





119 ALBERT STREET, BALLARAT CENTRAL RESIDENTIAL DEVELOPMENT

MGS ARCHITECTS PTY LTD 10-22 MANTON LANE MELBOURNE 3000

CLIENT UNITING VIC TAS

PROJECT : **119 ALBERT STREET** BALLARAT CENTRAL

PERSPECTIVE VIEW ALBERT STREET FRONTAGE

PERSPECTIVE VIEW ALBERT STREET (NORTH WEST CORNER)







DRAWING NUMBER @ A1 **TP0001**

DRAWING SCHEDULE						
SHEET NO.	TITTLE					
TP0001	COVER PAGE					
TP0101	EXISTING & DEMOLITION PLAN					
TP0201	PROPOSED GROUND FLOOR AND SITE PLAN					
TP0202	PROPOSED LEVEL 1 PLAN					
TP0203	PROPOSED LEVEL 2 PLAN					
TP0204	PROPOSED LEVEL 3 PLAN					
TP0205	PROPOSED ROOF PLAN					
TP0301	WEST AND NORTH ELEVATIONS					
TP0302	EAST AND SOUTH ELEVATIONS					
TP0401	PROPOSED SECTIONS					
TP0402	PROPOSED SECTIONS					
TP0501	TYPICAL APARTMENTS (BADS COMPLIANCE)					
TP0502	TYPICAL APARTMENTS (BADS COMPLIANCE)					
TP0901	EXISTING SHADOW DIAGRAM					
TP0902	PROPOSED SHADOW DIAGRAMS					

APARTMENT SCHEDULE

APT NO. OCCUPANCY		NLA (PCA Method)	POS		
GROUND I	EVEI	GROUND LEVEL	GROUND LEVEL		
G.01	2B1B	78.7 m ²	45.5 m ²		
G.02	1B1B	57.9 m ²	17.6 m ²		
		56.9 m ²	48.6 m ²		
G.04	2B1B	76.2 m ²	18.2 m ²		
LEVEL 1	2010	LEVEL 1	LEVEL 1		
1.01	2B1B	76.3 m ²	13.0 m ²		
1.02	1B1B	56.7 m ²	10.1 m ²		
1.03	1B1B	56.7 m ²	9.0 m ²		
1.04	1B1B	56.7 m ²	9.0 m ²		
1.05	1B1B	56.8 m ²	9.0 m ²		
1.06	1B1B	76.1 m ²	9.0 m ²		
1.07	2B1B	56.3 m ²	12.5 m ²		
LEVEL 2		LEVEL 2	LEVEL 2		
2.01	2B1B	76.3 m ²	13.0 m ²		
2.02	1B1B	56.7 m ²	10.1 m ²		
2.03	1B1B	56.7 m²	8.4 m ²		
2.04	1B1B	56.7 m²	8.5 m ²		
2.05	1B1B	56.8 m²	8.4 m ²		
2.06	1B1B	76.1 m ²	8.5 m ²		
2.07	2B1B	56.3 m²	12.5 m ²		
LEVEL 3		LEVEL 3	LEVEL 3		
3.01	2B1B	76.3 m²	13.0 m ²		
3.02	1B1B	56.3 m²	10.1 m ²		
3.03	1B1B	56.7 m²	8.4 m ²		
3.04	1B1B	56.7 m²	8.5 m ²		
3.05	1B1B	56.7 m²	8.4 m ²		
3.06	1B1B	56.8 m²	8.5 m ²		

PARTMENT TYPOLOGY SUMMARY

OCCUPANCY	COUNT
1B1B	17
2B1B	7
TOTAL APARTMENT: 24	


GROSS FLOOR AREA (GFA) SCHEDULE						
LEVEL	GFA					
GROUND LEVEL	380.9 m ²					
LEVEL 1	621.4 m ²					
LEVEL 2	619.1 m ²					
LEVEL 3	580.1 m ²					
TOTAL GFA	2201.5 m ²					


NOTE: PERSPECTIVE IMAGES ARE INDICATIVE ARTIS MPRESSION ONLY AND SHALL NOT BE USED FOR CONSTRUCTION



REPRODUCTION OF THE WHOLE OR PART OF THIS DOCUMENT CONSTITUTES AN INFRINGEMENT OF COPYRIGHT. THE INFORMATION, IDEAS AND CONCEPTS CONTAINED IN THIS DOCUMENT ARE CONFIDENTIAL. THE RECIPIENT(S) OF THIS DOCUMENT IS PROHIBITED FROM DISCLOSING SUCH INFORMATION, IDEAS AND CONCEPTS TO ANY PERSON WITHOUT THE PRIOR WRITTEN CONSENT OF MGS ARCHITECTS PTY LTD.

MGS ARCHITECTS PTY LTD ABN 13 006 488 302 I MGSARCHITECTS.COM.AU I T +61 3 9670 1800 10–22 MANTON LANE MELBOURNE 3000 AUSTRALIA

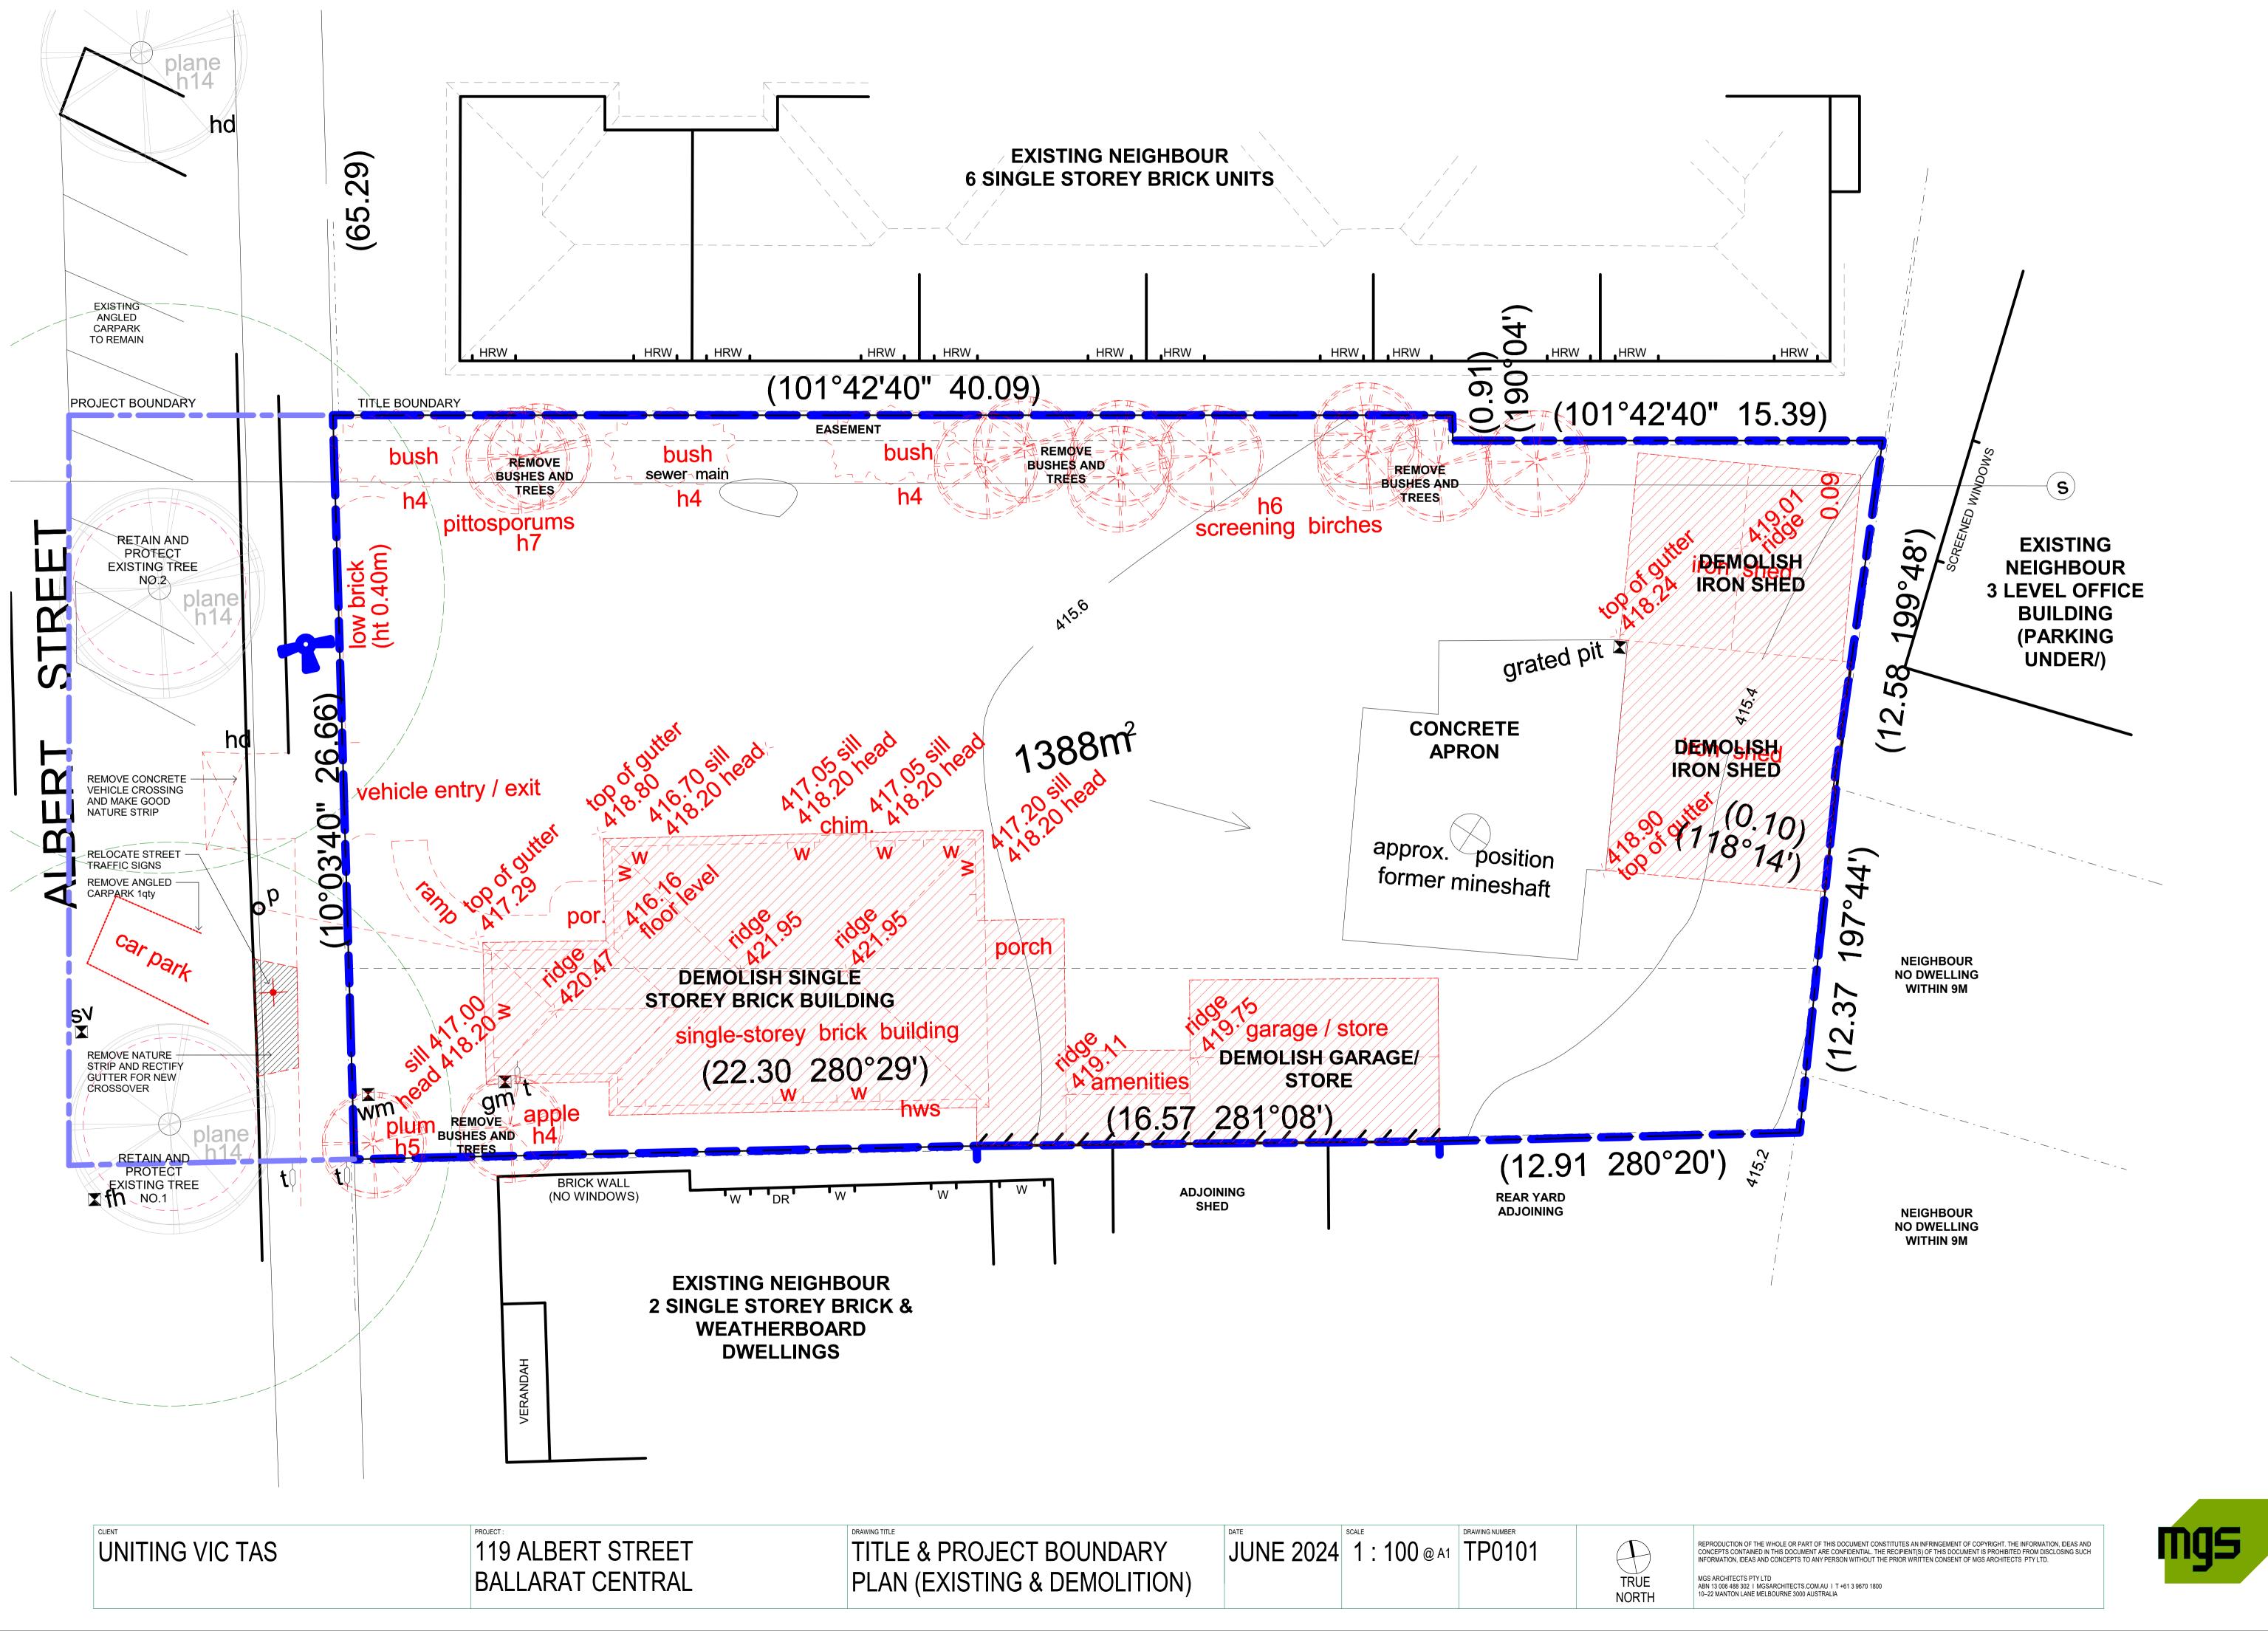

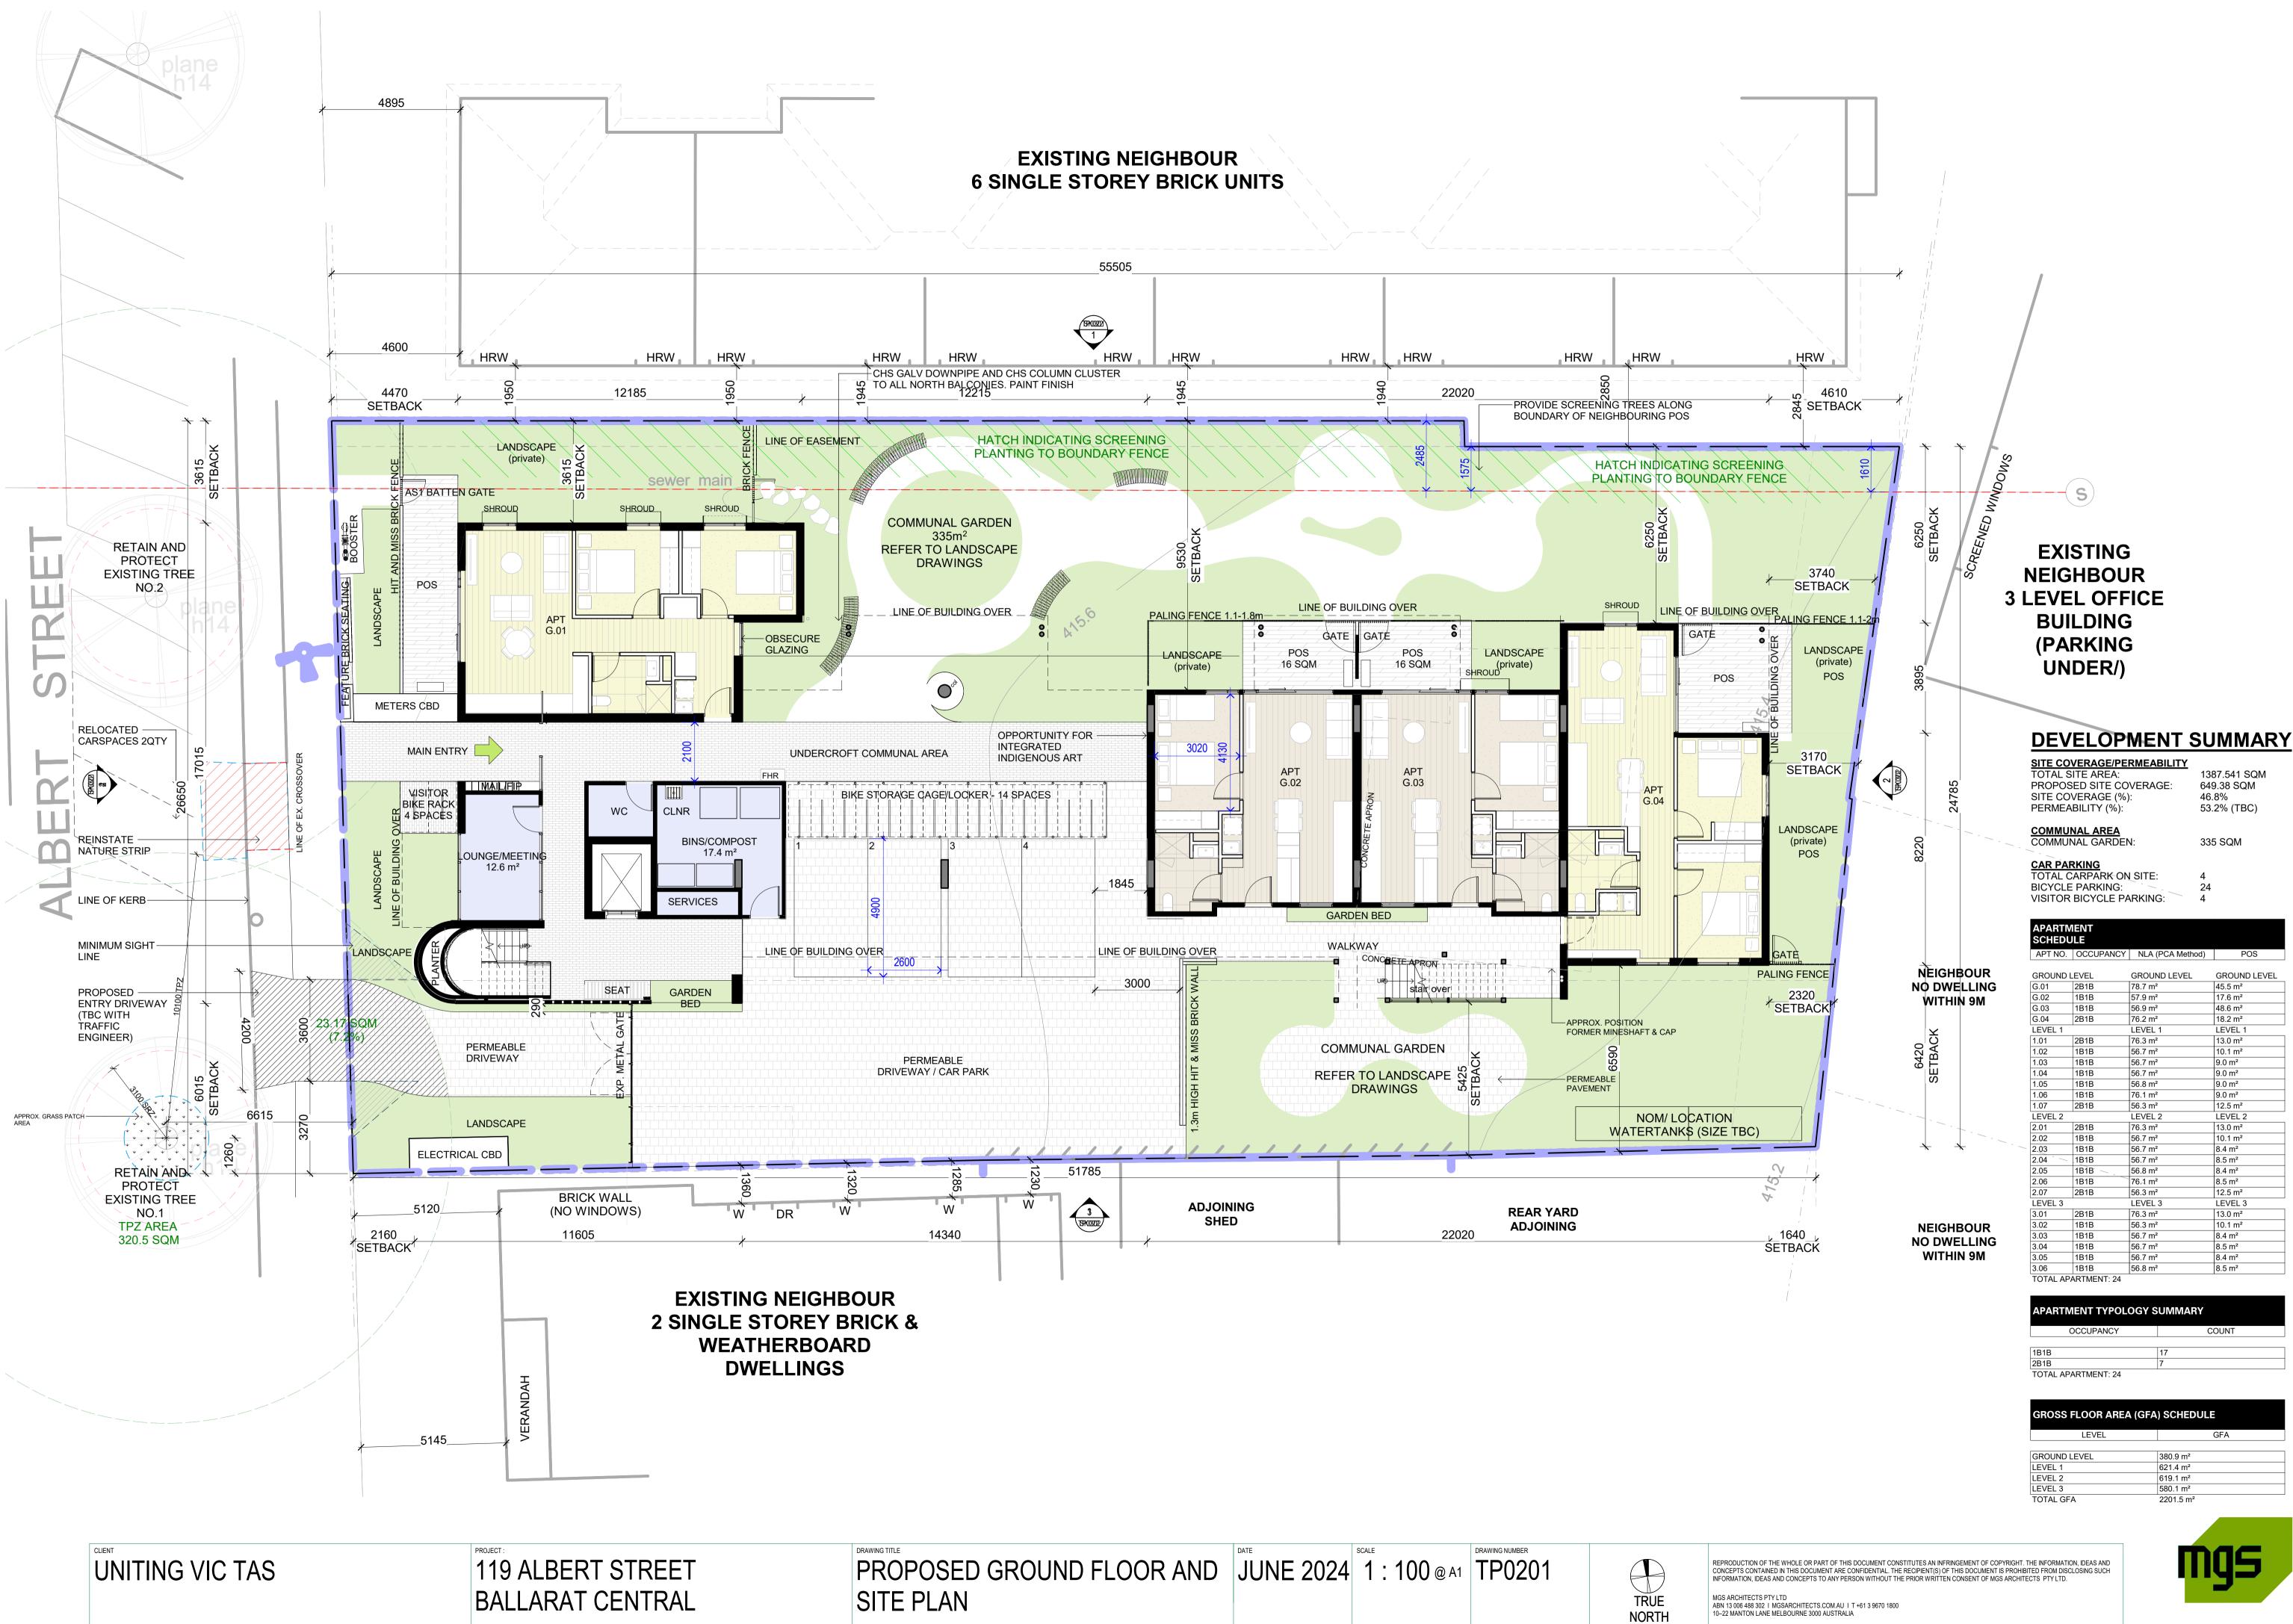




mgs





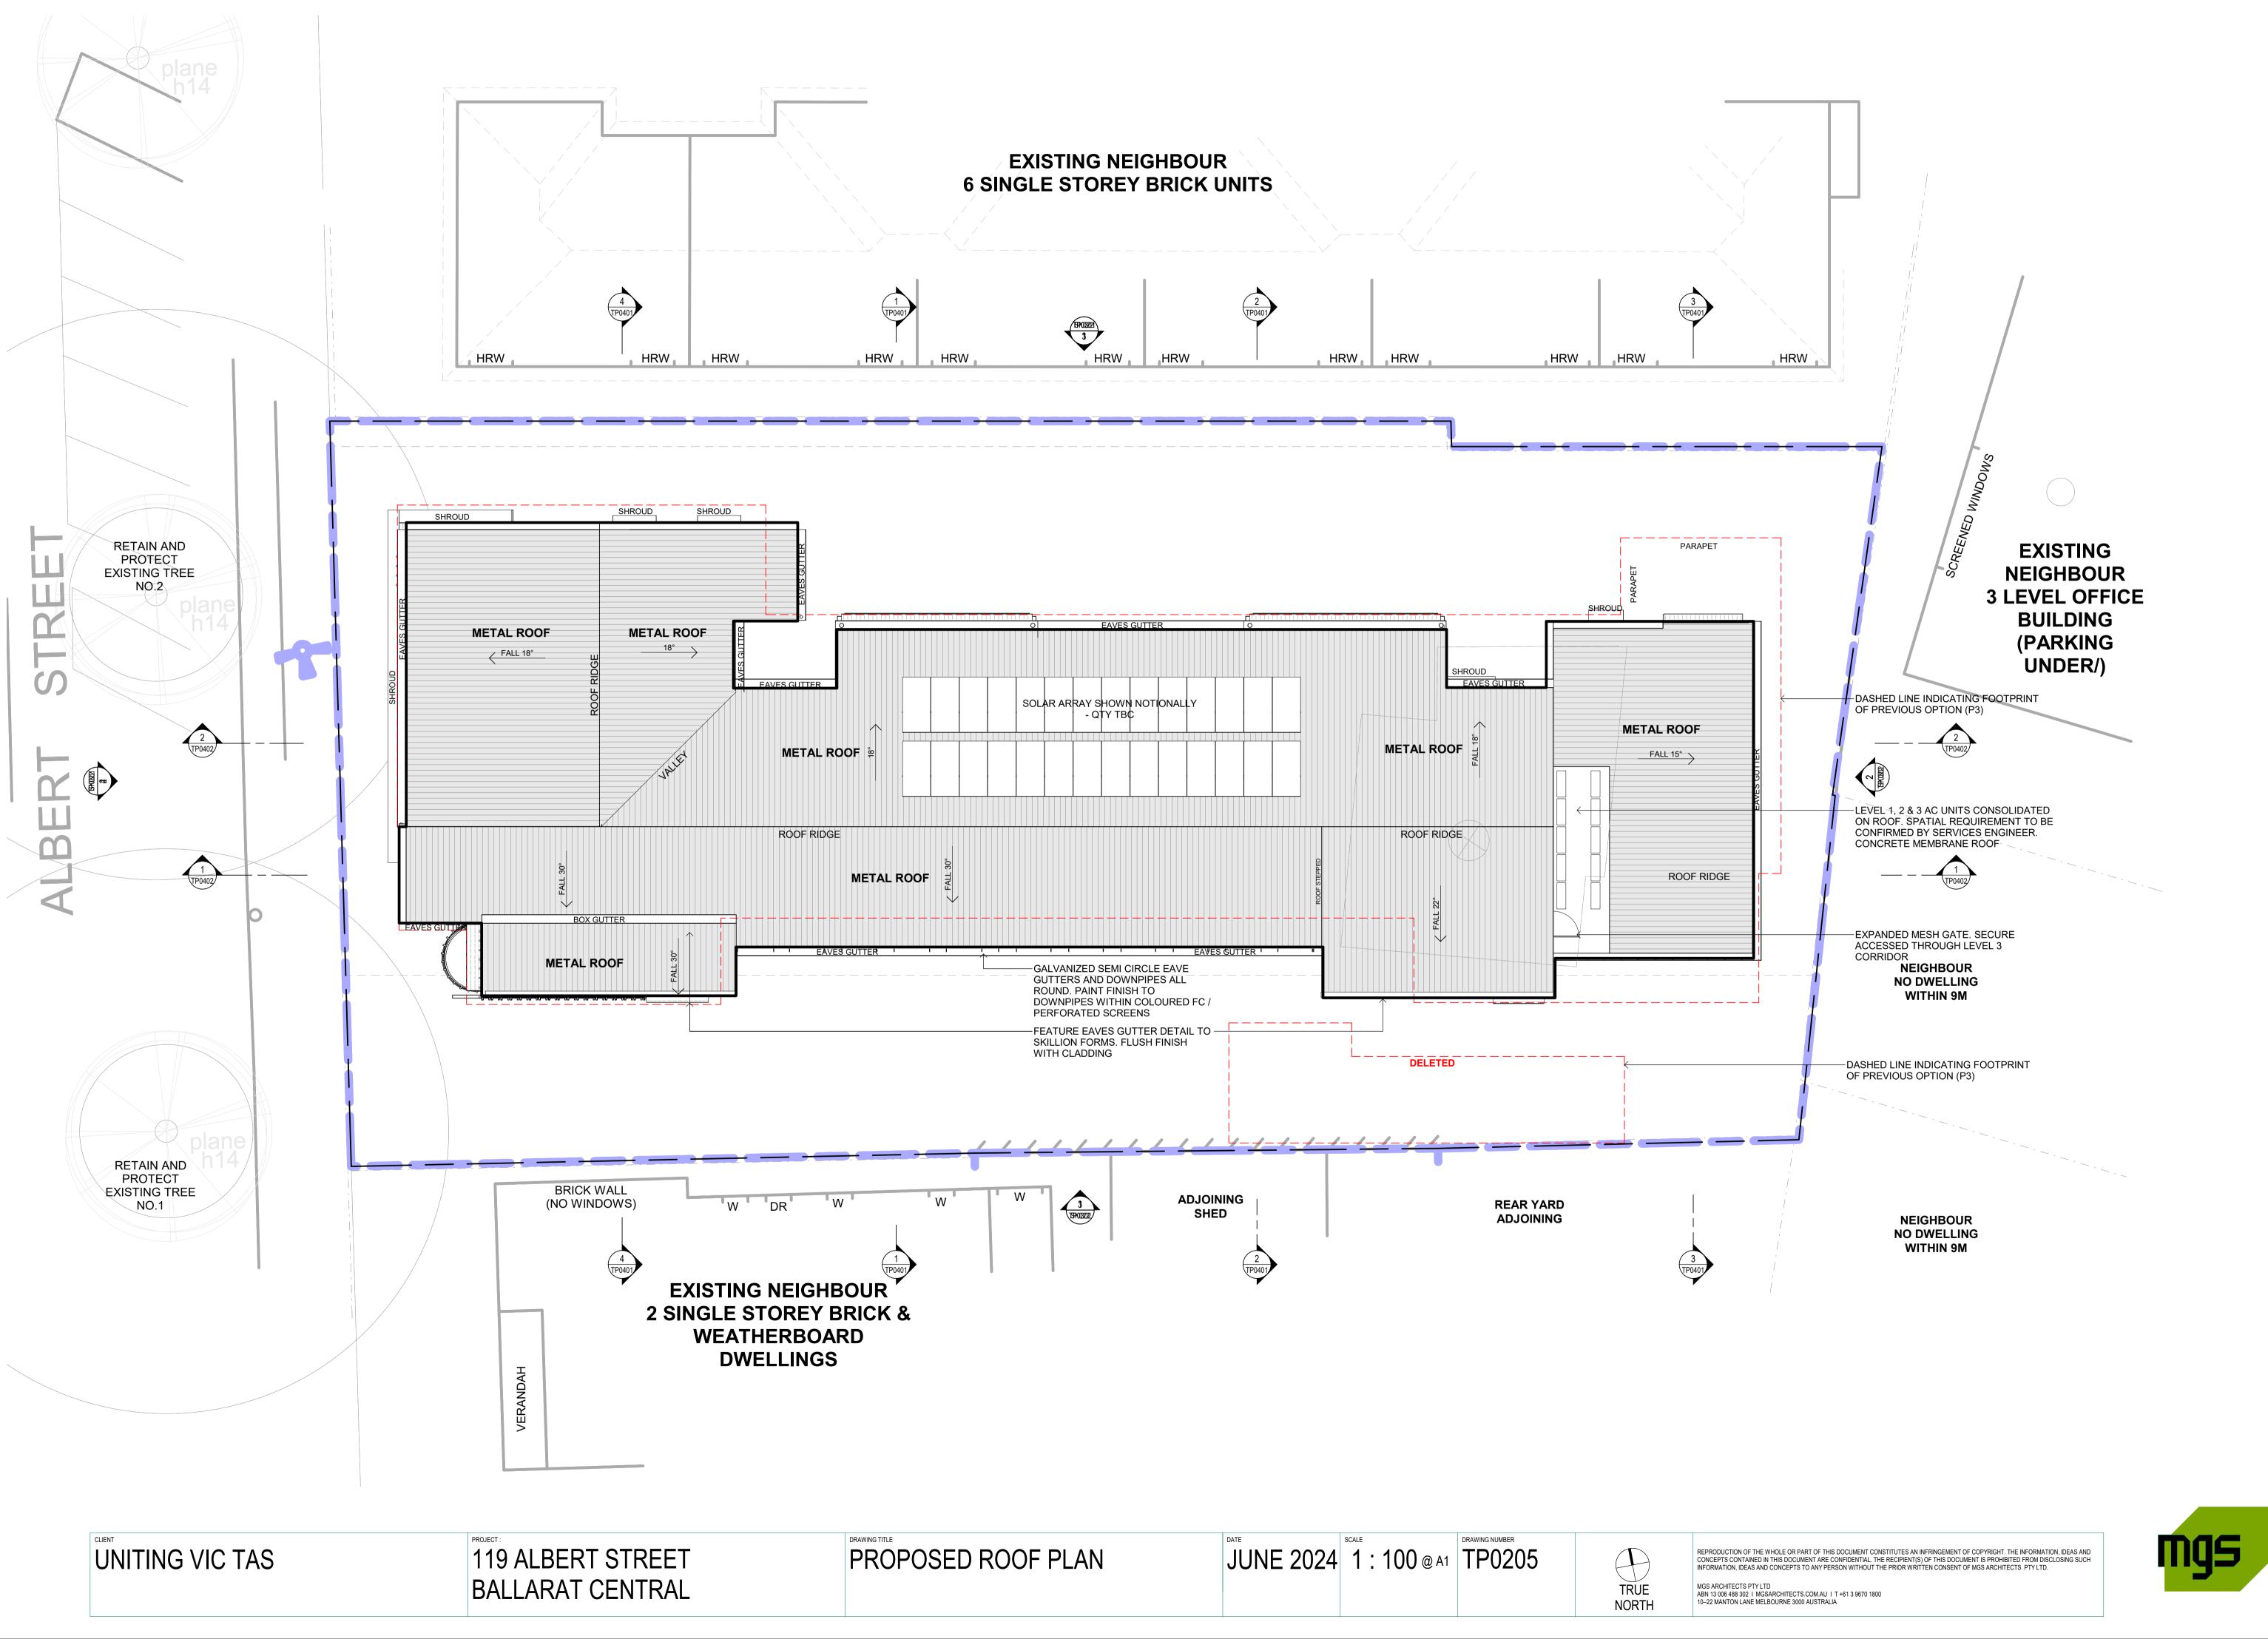





PROPOSED NORTH ELEVATION

119 ALBERT STREET

BALLARAT CENTRAL

PROJECT :



DRAWING TITLE WEST AND NORTH ELEVATIONS

SCALE JUNE 2024 As indicated

@ A1 **TP0301**

DRAWING NUMBER

EXTERNAL MATERIAL SCHEDULE

BR1	BRICK FINISH WALL/FENCE.




REPRODUCTION OF THE WHOLE OR PART OF THIS DOCUMENT CONSTITUTES AN INFRINGEMENT OF COPYRIGHT. THE INFORMATION, IDEAS AND CONCEPTS CONTAINED IN THIS DOCUMENT ARE CONFIDENTIAL. THE RECIPIENT(S) OF THIS DOCUMENT IS PROHIBITED FROM DISCLOSING SUCH INFORMATION, IDEAS AND CONCEPTS TO ANY PERSON WITHOUT THE PRIOR WRITTEN CONSENT OF MGS ARCHITECTS PTY LTD.

MGS ARCHITECTS PTY LTD


CLIENT UNITING VIC TAS

PROJECT : **119 ALBERT STREET** BALLARAT CENTRAL


PROPOSED SOUTH ELEVATION

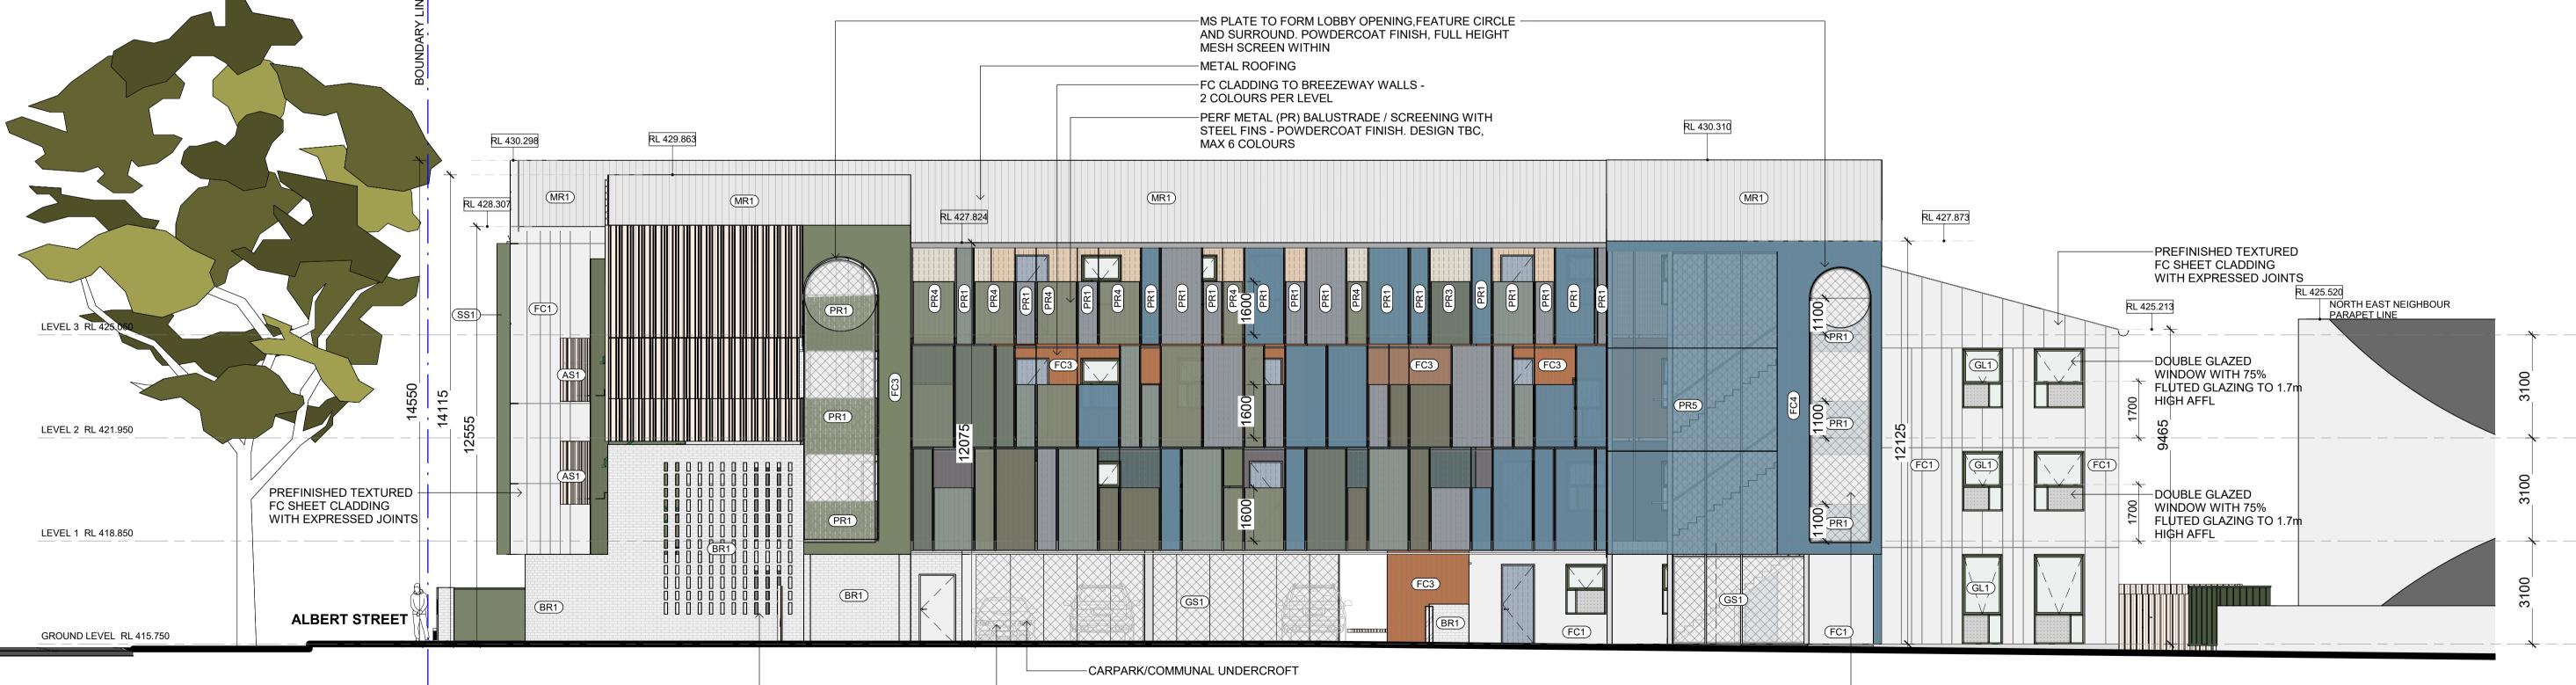

PROPOSED EAST ELEVATION

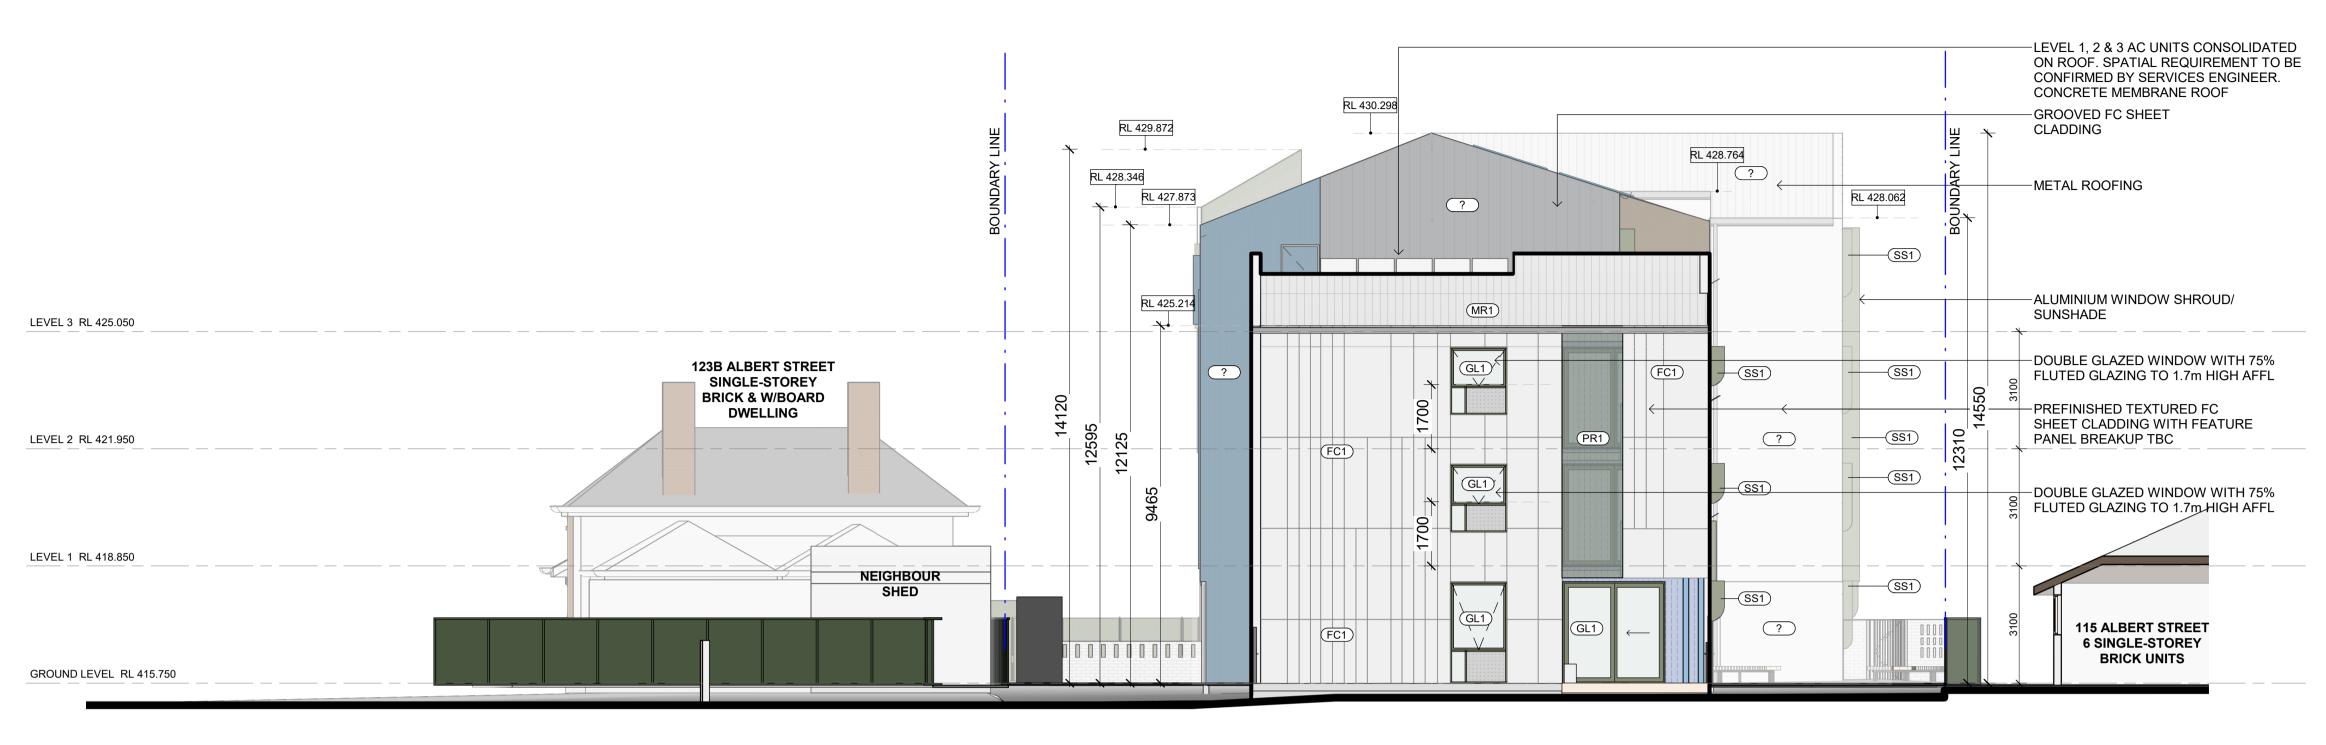

DATE SCALE DRAWING NUMBER TO DRAWING NUMBER TO DRAWING NUMBER

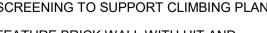

EAST AND SOUTH ELEVATIONS

-FEATURE BRICK WALL WITH HIT AND MISS PATTERN 900mm AFFL


DRAWING TITLE

	BR1
CARPARK/COMMUNAL UNDERCROFT	
SCREENING TO SUPPORT CLIMBING PLANTS	


EXTERNAL MATERIAL SCHEDULE

BR1	BRICK FINISH WALL/FENCE.
FC1	TEXTURED FIBRE CEMENT CLADDING PRE-FINISHED 1
FC2	TEXTURED FIBRE CEMENT CLADDING PRE-FINISHED 2
FC3	TEXTURED FIBRE CEMENT CLADDING PRE-FINISHED 3
FC4	TEXTURED FIBRE CEMENT CLADDING PRE-FINISHED 4
FC5	GROOVED FIBRE CEMENT CLADDING - PAINT FINISH
AS1	TIMBER LOOK ALUMINIUM BATTENS SCREENING/BALUSTRADE SYSTEM 1 (STAIR CORE)
PR1	EXPANDED MESH SCREENING/BALUSTRADE WALKWAY
GS1	WIRE MESH SCREEN (NOM. TENSILE MESH)
GL1	DOUBLE GLAZED CLEAR ALUMINIUM WINDOW SYSTEM
GL2	DOUBLE GLAZED FLUTED GLAZING ALUMINIUM WINDOW SYSTEM
MR1	CORUGATED METAL ROOFING
SS1	ALUMINIUM WINDOW SUNSHADE/SHROUD
PL1	TIMBER PALING FENCE IN PAINT FINISH
WR1	TENSIONED PLANTING WIRE SCREEN INTEGRATED INTO PLANTER BOX

mgs

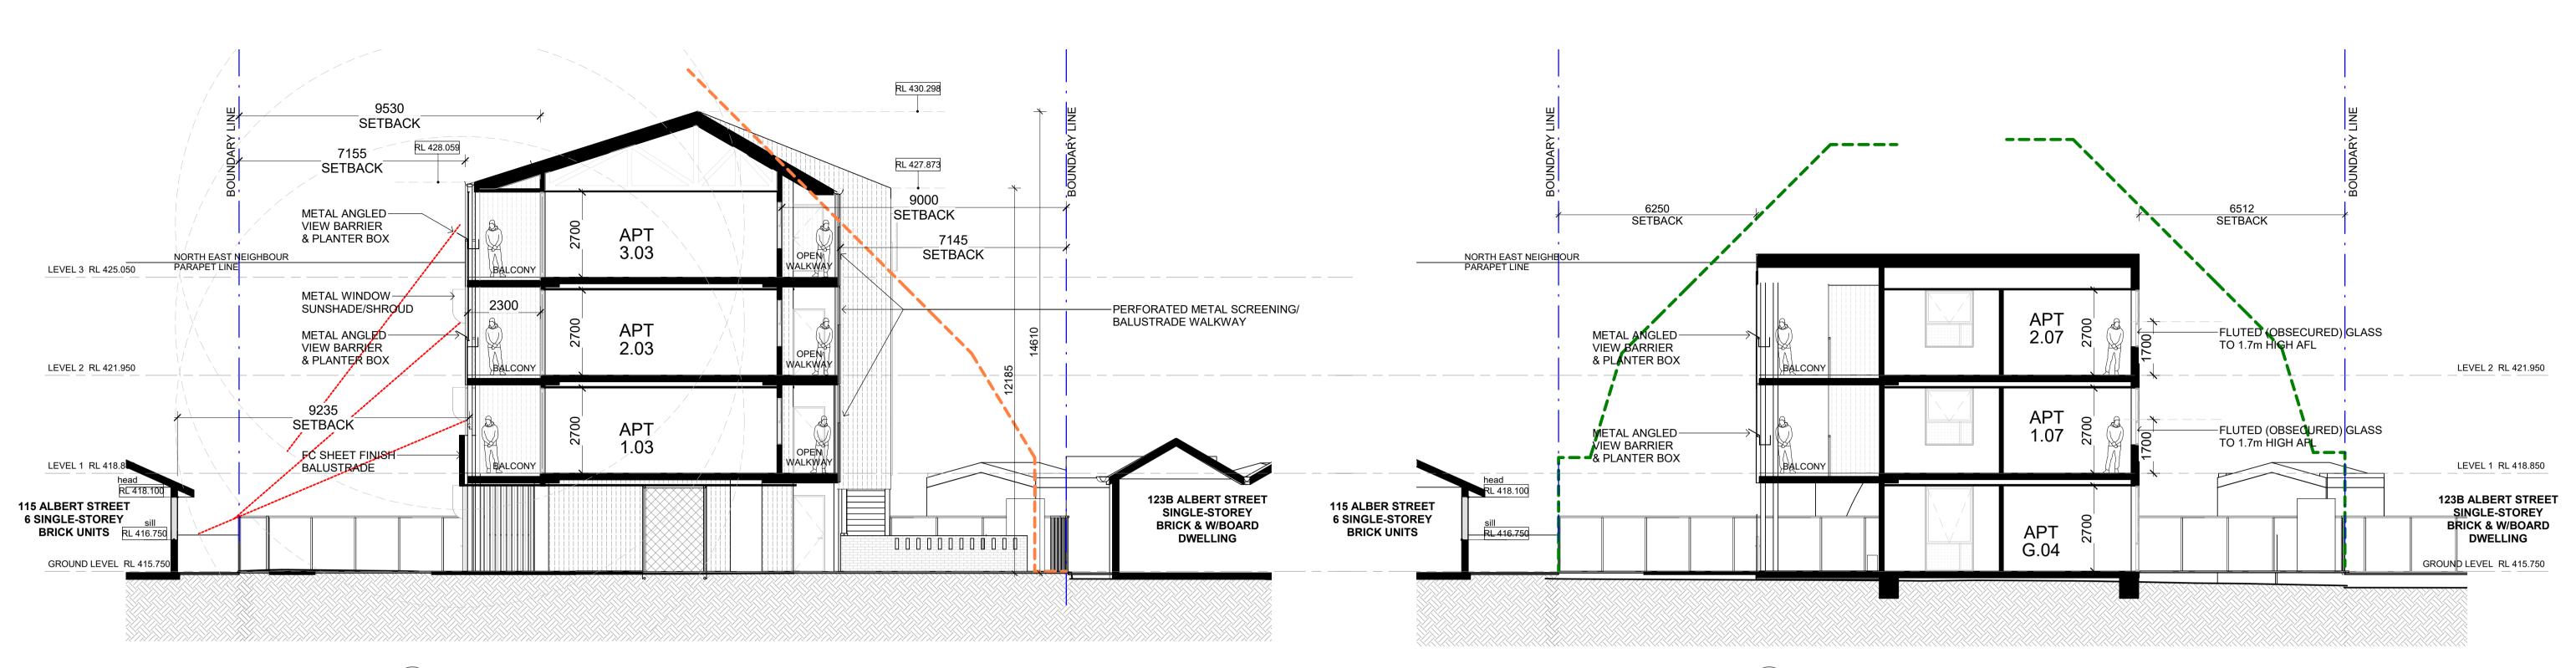

1 SECTION 1 SCALE 1:100

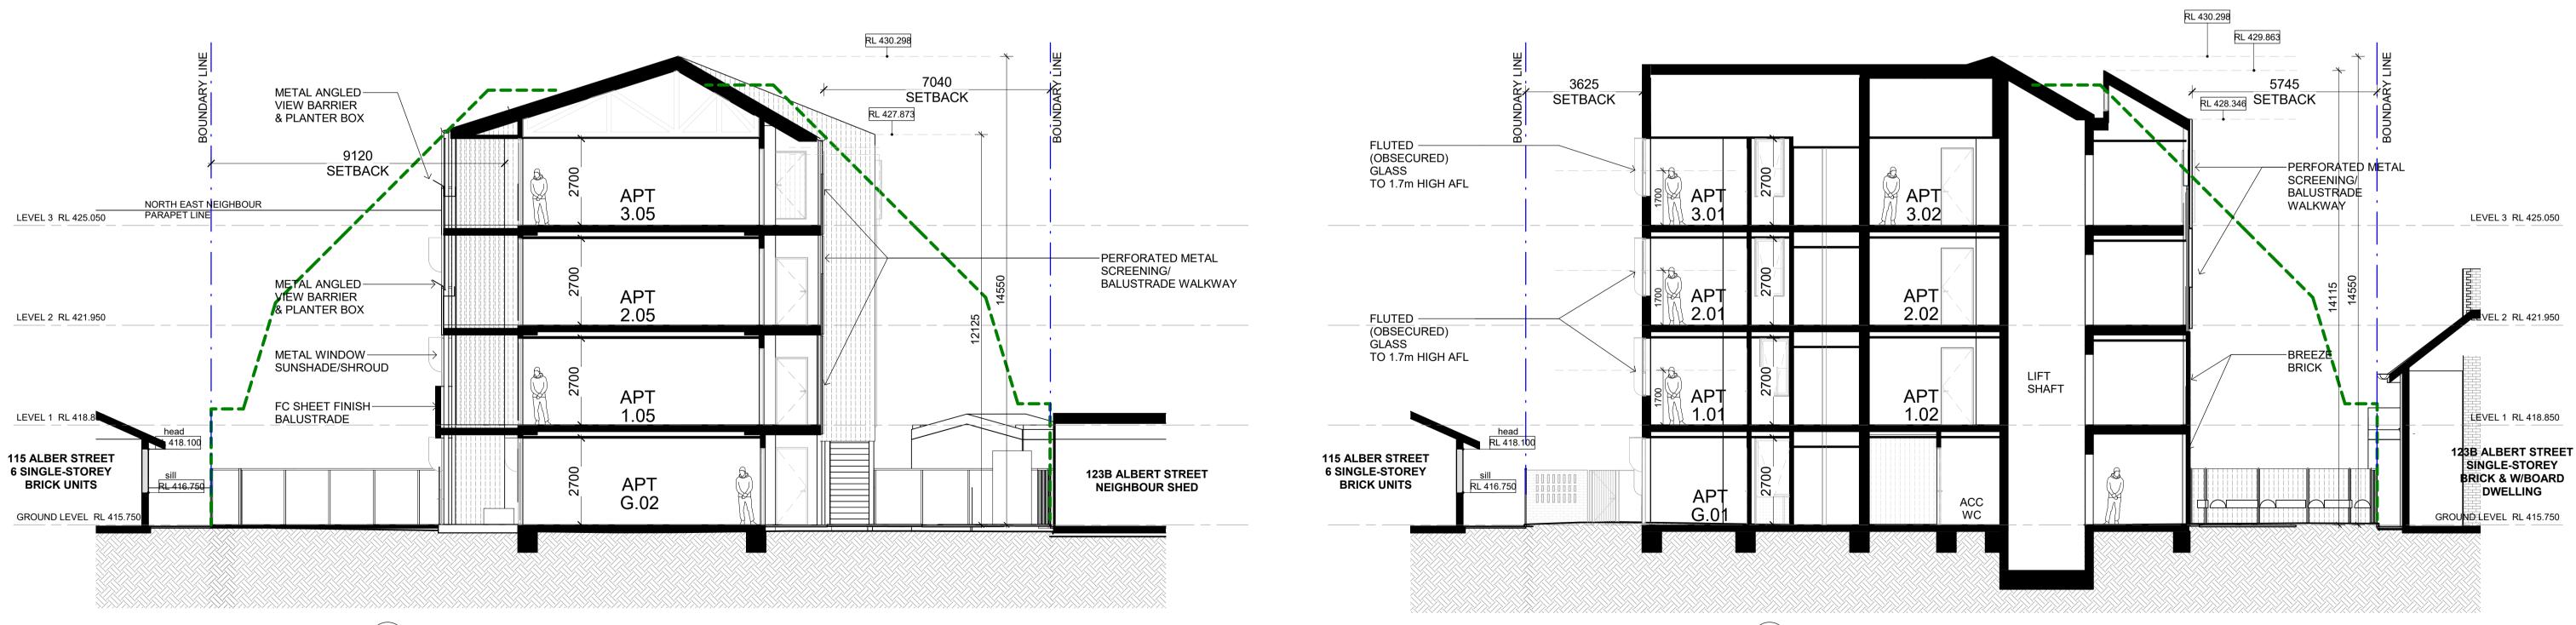

2 SECTION 2 SCALE 1 : 100

UNITING VIC TAS

PROJECT: 119 ALBERT STREET BALLARAT CENTRAL

3 SECTION 3 SCALE 1:100

4 SECTION 4 SCALE 1:100

PROPOSED SECTIONS

DATESCALEDRAWING NUMBERJUNE 20241:100@A1TP0401




REPRODUCTION OF THE WHOLE OR PART OF THIS DOCUMENT CONSTITUTES AN INFRINGEMENT OF COPYRIGHT. THE INFORMATION, IDEAS AND CONCEPTS CONTAINED IN THIS DOCUMENT ARE CONFIDENTIAL. THE RECIPIENT(S) OF THIS DOCUMENT IS PROHIBITED FROM DISCLOSING SUCH INFORMATION, IDEAS AND CONCEPTS TO ANY PERSON WITHOUT THE PRIOR WRITTEN CONSENT OF MGS ARCHITECTS PTY LTD.

MGS ARCHITECTS PTY LTD ABN 13 006 488 302 I MGSARCHITECTS.COM.AU I T +61 3 9670 1800 10–22 MANTON LANE MELBOURNE 3000 AUSTRALIA


CLIENT UNITING VIC TAS

PROJECT : **119 ALBERT STREET** BALLARAT CENTRAL

2 SECTION 6 (LONG SECTION) SCALE 1:100

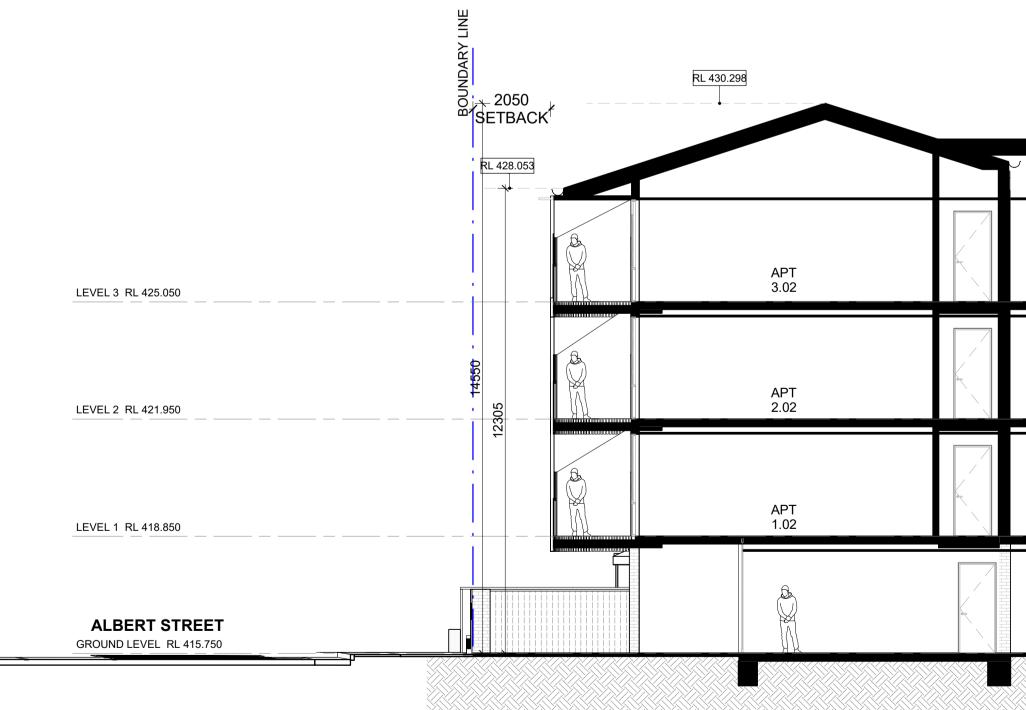



1 SECTION 5 (LONG SECTION) SCALE 1:100

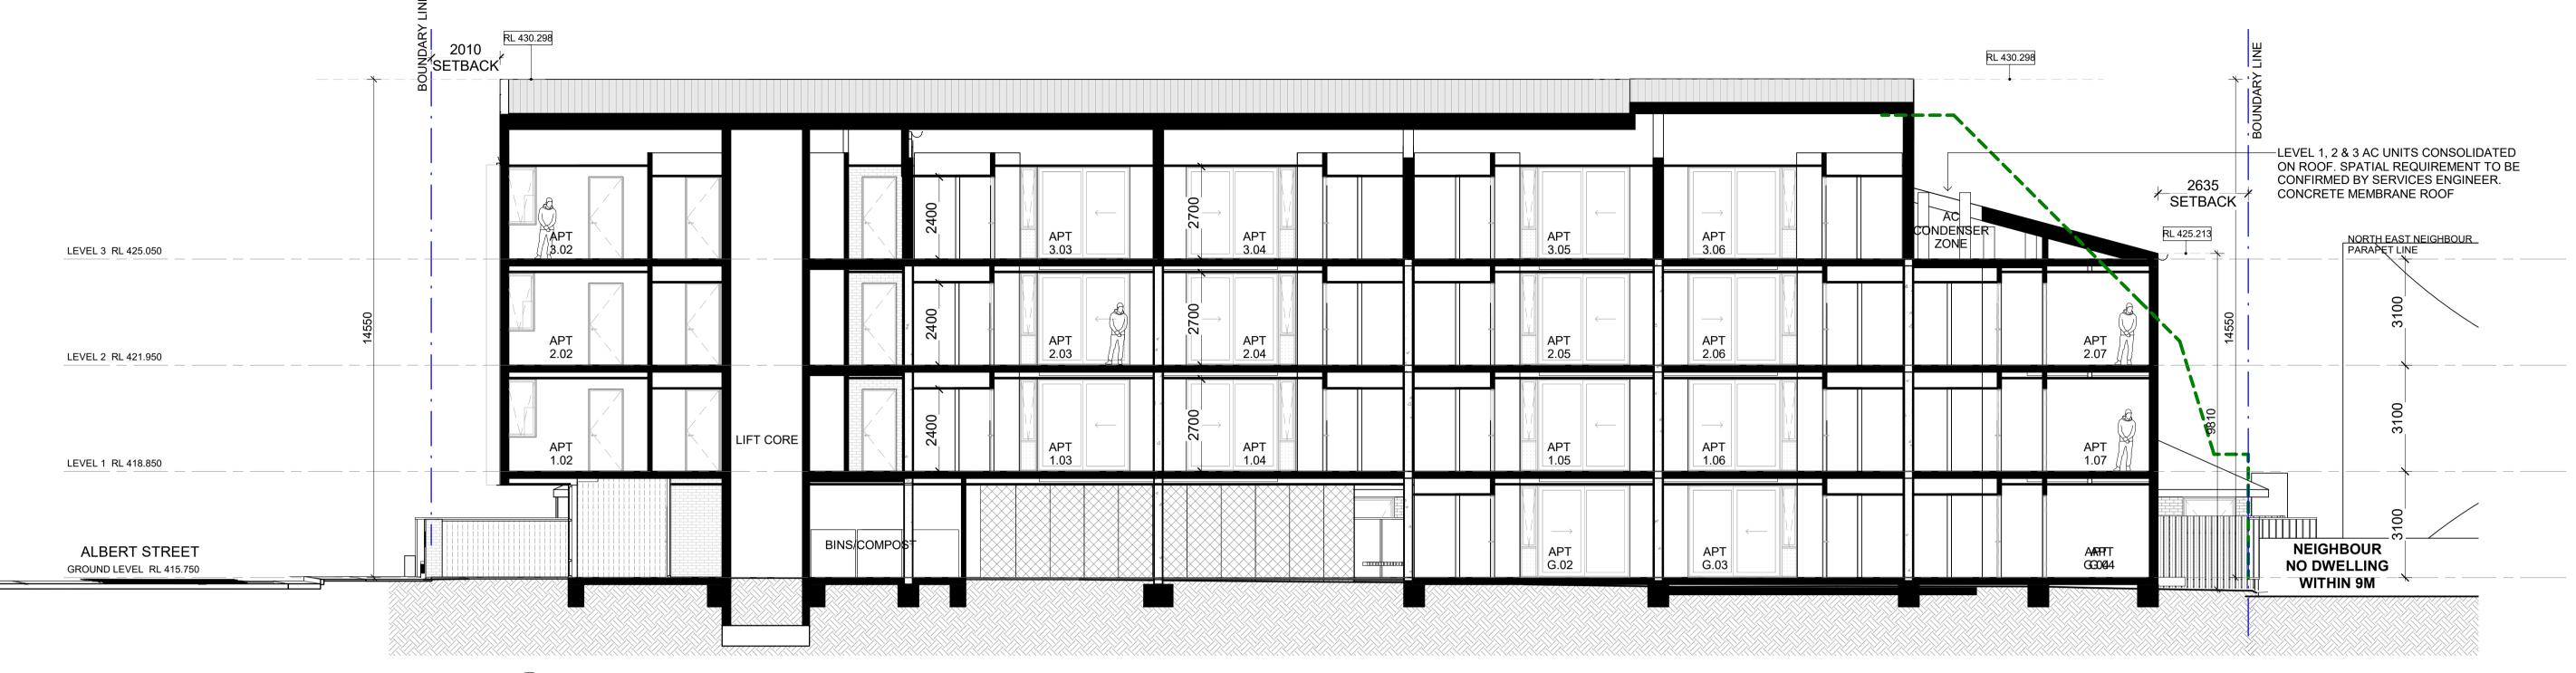

λ.			
$ \rightarrow APT 3.04 \qquad \qquad$			AC CONDENSER ZONE
	APT 2.05		
	APT 1.05		
		APT G.03	

DRAWING TITLE **PROPOSED SECTIONS** DATESCALEDRAWING NUMBERJUNE 20241:100@A1TP0402

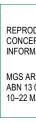


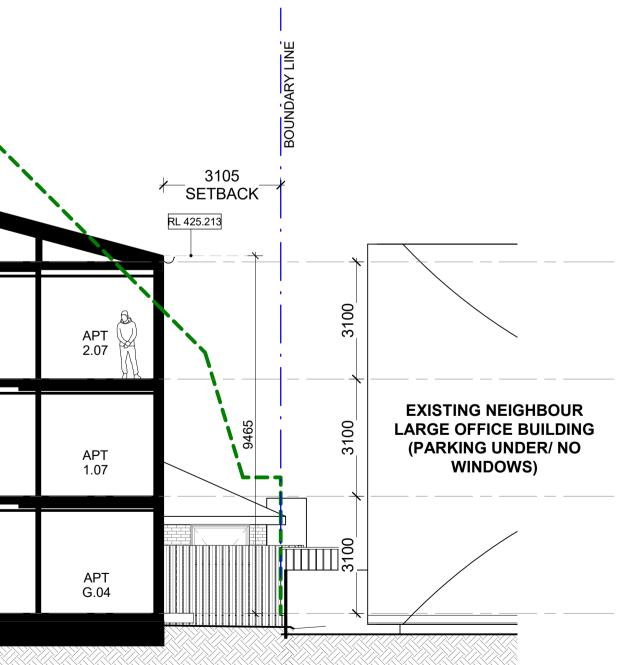




REPRODUCTION OF THE WHOLE OR PART OF THIS DOCUMENT CONSTITUTES AN INFRINGEMENT OF COPYRIGHT. THE INFORMATION, IDEAS AND CONCEPTS CONTAINED IN THIS DOCUMENT ARE CONFIDENTIAL. THE RECIPIENT(S) OF THIS DOCUMENT IS PROHIBITED FROM DISCLOSING SUCH INFORMATION, IDEAS AND CONCEPTS TO ANY PERSON WITHOUT THE PRIOR WRITTEN CONSENT OF MGS ARCHITECTS PTY LTD.

MGS ARCHITECTS PTY LTD ABN 13 006 488 302 I MGSARCHITECTS.COM.AU I T +61 3 9670 1800 10–22 MANTON LANE MELBOURNE 3000 AUSTRALIA

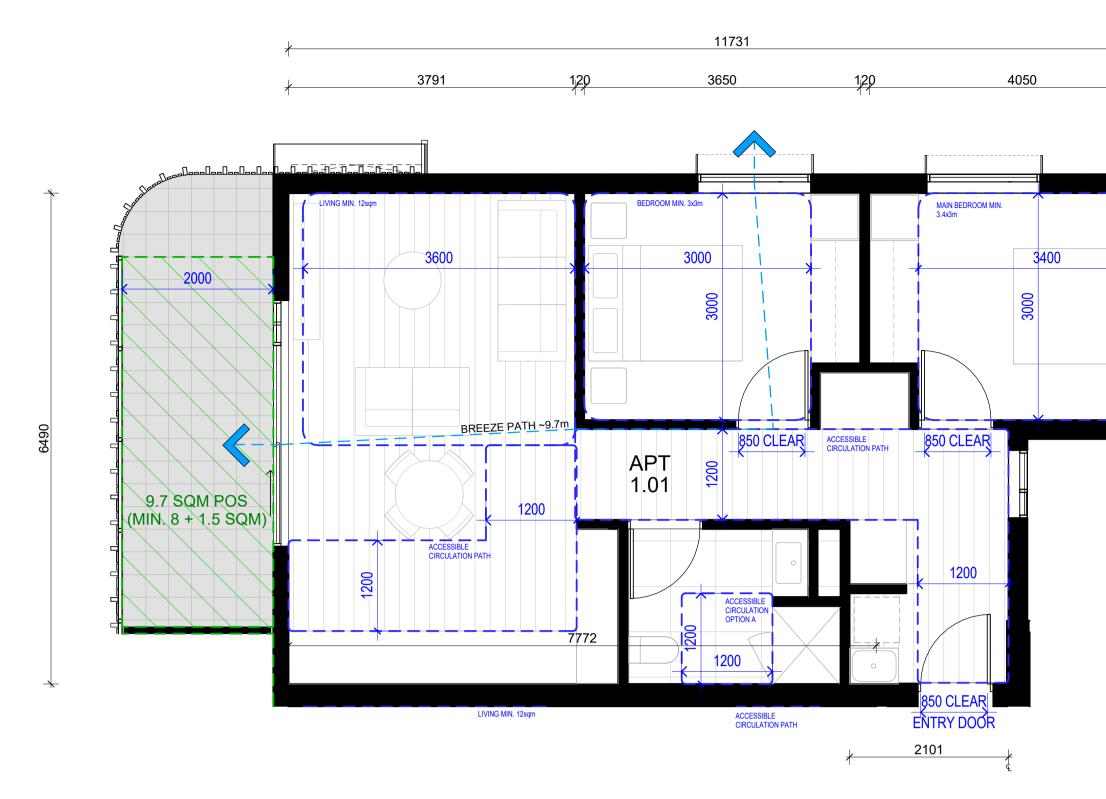

BADS ANALYSIS - 1.01 (TYPICAL TYPE A - 2B1B) SCALE 1:50

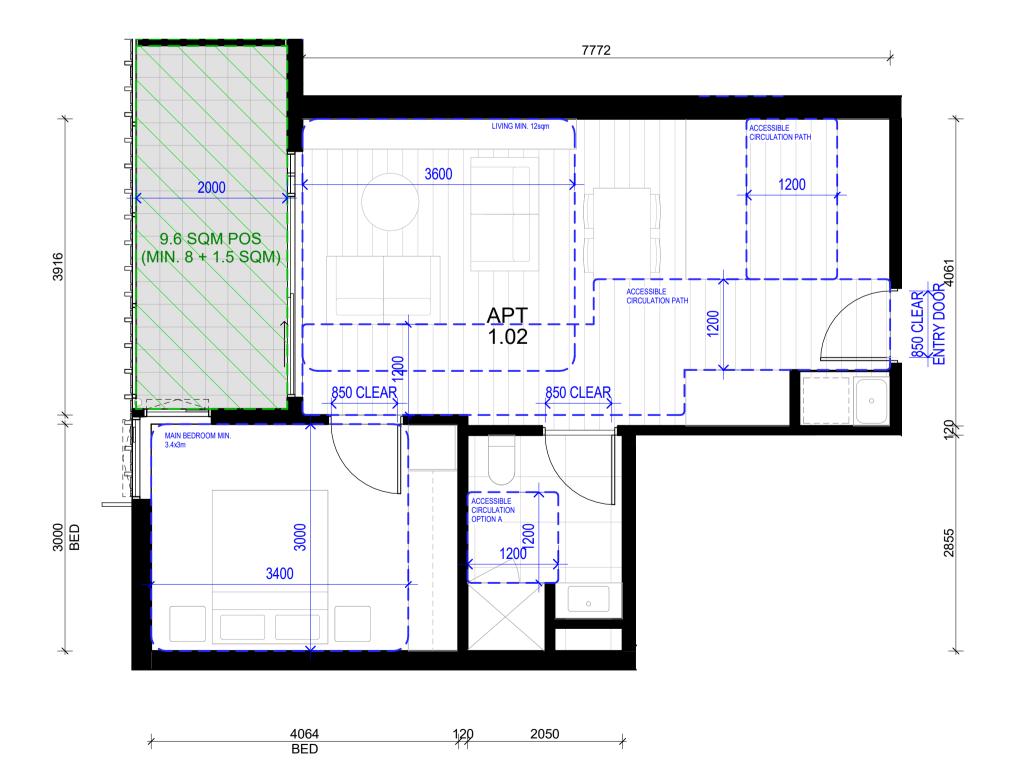

BADS ANALYSIS - 1.02 (TYPICAL TYPE B - 1B1B)

PROJECT :


119 ALBERT STREET


BALLARAT CENTRAL

SCALE 1:50


UNITING VIC TAS


CLIENT

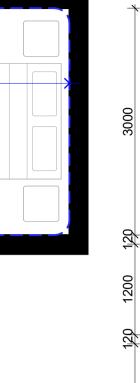

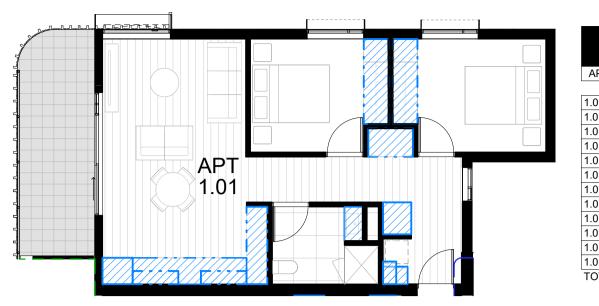

STORAGE SCHEDULE - 1.01						
APT. NO	VOLUME					
1.01	FRIDGE O'HEAD	0.34 m³				
1.01	KITCHEN O'HEAD	0.36 m³				
1.01	KITCHEN O'HEAD	0.36 m³				
1.01	KITCHEN U'BENCH	1.69 m³				
1.01	LAUNDRY O'HEAD	0.19 m ³				
1.01	LAUNDRY U'BENCH	0.24 m ³				
1.01	PANTRY	2.59 m ³				
1.01	ROBE	3.50 m ³				
1.01	ROBE	3.50 m ³				
1.01	STORAGE CBD	2.04 m ³				
1.01	STORAGE CBD	1.46 m³				
1.01	VANITY	0.30 m ³				
TOTAL		16.56 m³				

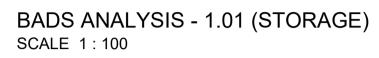

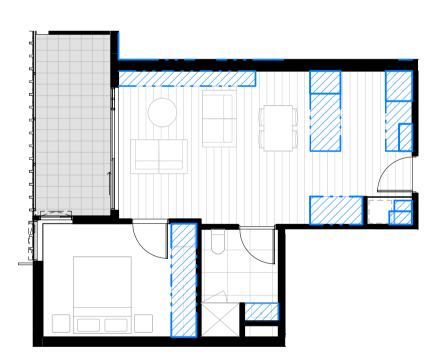


BADS ANALYSIS - 1.02 (STORAGE) SCALE 1:100

STORAGE SCHEDULE - 1.02								
APT NO. STORAGE TYPE VOLUME								
1.02	FRIDGE O'HEAD	0.34 m³						
1.02	KITCHEN O'HEAD	0.21 m³						
1.02	KITCHEN U'BENCH	0.74 m ³						
1.02	KITCHEN U'BENCH	0.97 m ³						
1.02	LAUNDRY O'HEAD	0.19 m ³						
1.02	LAUNDRY U'BENCH	0.24 m ³						
1.02	LOW STORAGE CBD	0.65 m³						
1.02	PANTRY	1.11 m ³						
1.02	ROBE	4.78 m ³						
1.02	STORAGE CBD	2.35 m ³						
1.02	VANITY	0.30 m³						
TOTAL		11.88 m ³						

TYPICAL APARTMENTS (BADS COMPLIANCE)

JUNE 2024 As DRAWING NUMBER @ A1 **TP0501** indicated

LEGEND DWELLING AMENITY (BADS COMPLIANCE)

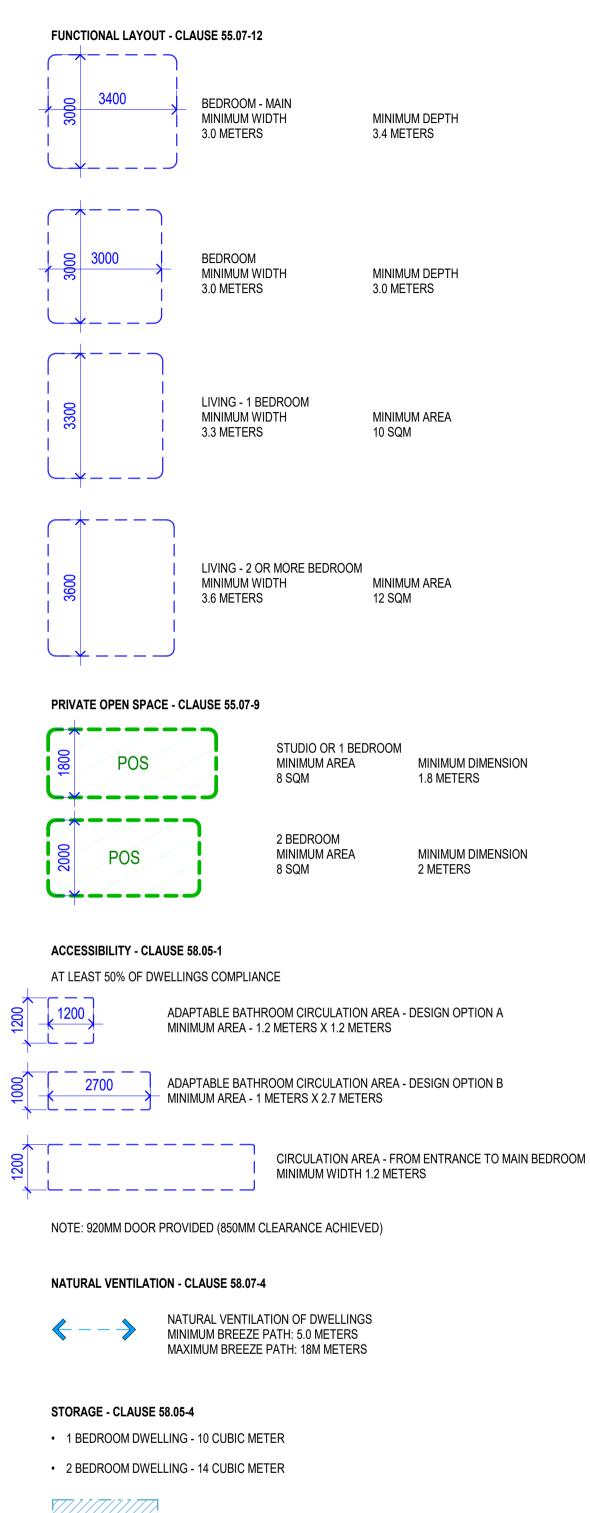


STORAGE VOLUME ANALYSIS


ROOM DEPTH - CLAUSE 58.07-2

THE FOLLOWING CEILING HEIGHT IS ADOPTED THROUGHT THE DEVELOPMENT:

- OPEN PLAN LIVING ROOM/KITCHEN 2.7M (LOCALIZED BULKHEAD ONLY TO ALLOW SERVICES 2.4M)
- BEDROOM 2.7M (LOCALIZED BULKHEAD ONLY TO ALLOW SERVICES 2.4M)
- BATHROOM 2.4M



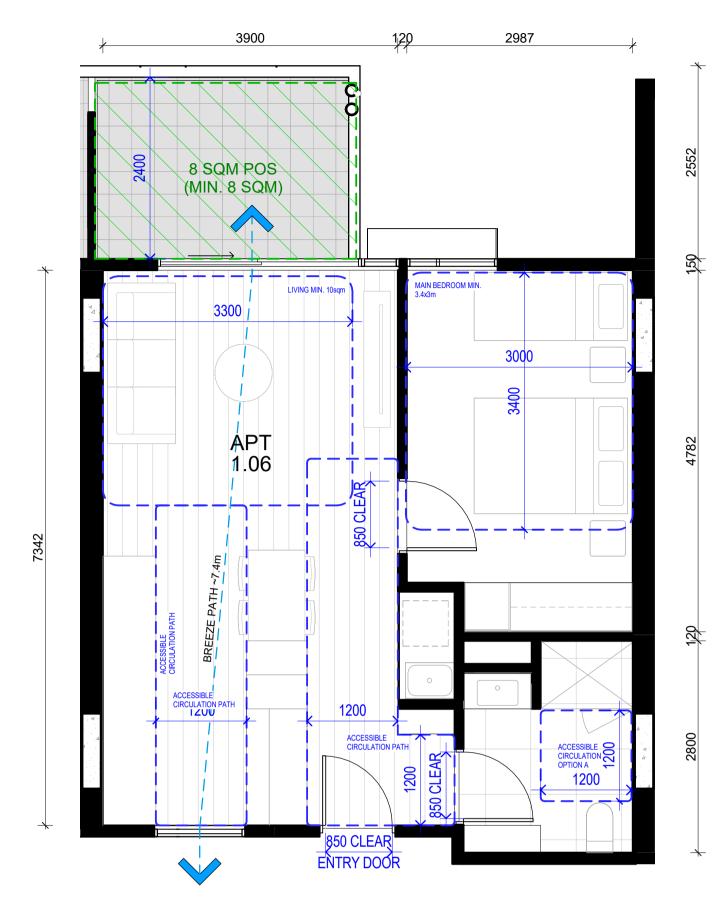

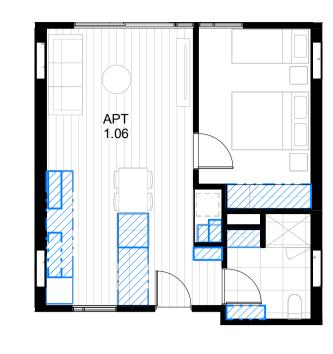

	STORAGE SCHEDULE - 1.0	6
APT NO.	VOLUME	
1.06	FRIDGE O'HEAD	0.29 m ³
1.06	KITCHEN O'HEAD	0.29 m ³
1.06	KITCHEN O'HEAD	0.35 m ³
1.06	KITCHEN U'BENCH	0.99 m ³
1.06	KITCHEN U'BENCH	1.57 m ³
1.06	LAUNDRY O'HEAD	0.19 m ³
1.06	LAUNDRY U'BENCH	0.24 m ³
1.06	PANTRY	1.66 m ³
1.06	ROBE	3.49 m ³
1.06	STORAGE CBD	0.57 m³
1.06	STORAGE CBD	0.84 m³
1.06	VANITY	0.30 m³
TOTAL		10.79 m ³


BADS ANALYSIS - 1.06 (TYPICAL TYPE C - 1B1B) SCALE 1:50


APARTMENT BADS COMPLIANCE SUMMARY

									10050				CROSS
APT NO.	OCCUPANCY	APT TYPE	PRIMARY BEDROOM SIZE 3x3.4m	SECONDARY BEDROOM SIZE 3x3m	INTERNAL / LIVING ROOM WIDTH (1B -3.3m & 2-3B - 3.6m)	LIVING ROOM AREA (1B-10m2 & 2-3B-12m2)	HABITABLE ROOM MAX. 9m	LIVING AREA CEILING HEIGHT MIN.2.7m	ACCES ENTRY DOOR & INTERNAL CIRCULATION 1.2m CLEAR PATH	BATHROOM	POS AREA & DEPTH		
GROUND	LEVEL												
G.01	2B1B	TYPE A	Yes	Yes	Yes	Yes	Yes	Yes	Yes	Yes	Yes	Yes	Yes
G.02	1B1B	TYPE C	Yes		Yes	Yes	Yes	Yes	Yes	Yes	Yes	Yes	Yes
G.03	1B1B	TYPE C	Yes		Yes	Yes	Yes	Yes	Yes	Yes	Yes	Yes	Yes
G.04	2B1B	TYPE D	Yes	Yes	Yes	Yes	Yes	Yes	Yes	Yes	Yes	Yes	Yes
LEVEL 1													
1.01	2B1B	TYPE A	Yes	Yes	Yes	Yes	Yes	Yes	Yes	Yes	Yes	Yes	Yes
1.02	1B1B	TYPE B	Yes		Yes	Yes	Yes	Yes	Yes	Yes	Yes	Yes	No
1.03	1B1B	TYPE C	Yes		Yes	Yes	Yes	Yes	Yes	Yes	Yes	Yes	Yes
1.04	1B1B	TYPE C	Yes		Yes	Yes	Yes	Yes	Yes	Yes	Yes	Yes	Yes
1.05	1B1B	TYPE C	Yes		Yes	Yes	Yes	Yes	Yes	Yes	Yes	Yes	Yes
1.06	1B1B	TYPE C	Yes		Yes	Yes	Yes	Yes	Yes	Yes	Yes	Yes	Yes
1.07	2B1B	TYPE D	Yes	Yes	Yes	Yes	Yes	Yes	Yes	Yes	Yes	Yes	Yes
LEVEL 2													
2.01	2B1B	TYPE A	Yes	Yes	Yes	Yes	Yes	Yes	Yes	Yes	Yes	Yes	Yes
2.02	1B1B	TYPE B	Yes		Yes	Yes	Yes	Yes	Yes	Yes	Yes	Yes	No
2.03	1B1B	TYPE C	Yes		Yes	Yes	Yes	Yes	Yes	Yes	Yes	Yes	Yes
2.04	1B1B	TYPE C	Yes		Yes	Yes	Yes	Yes	Yes	Yes	Yes	Yes	Yes
2.05	1B1B	TYPE C	Yes		Yes	Yes	Yes	Yes	Yes	Yes	Yes	Yes	Yes
2.06	1B1B	TYPE C	Yes		Yes	Yes	Yes	Yes	Yes	Yes	Yes	Yes	Yes
2.07	2B1B	TYPE D	Yes	Yes	Yes	Yes	Yes	Yes	Yes	Yes	Yes	Yes	Yes
LEVEL 3			_										
3.01	2B1B	TYPE A	Yes	Yes	Yes	Yes	Yes	Yes	Yes	Yes	Yes	Yes	Yes
3.02	1B1B	TYPE B	Yes		Yes	Yes	Yes	Yes	Yes	Yes	Yes	Yes	No
3.03	1B1B	TYPE C	Yes		Yes	Yes	Yes	Yes	Yes	Yes	Yes	Yes	Yes
3.04	1B1B	TYPE C	Yes		Yes	Yes	Yes	Yes	Yes	Yes	Yes	Yes	Yes
3.05	1B1B	TYPE C	Yes		Yes	Yes	Yes	Yes	Yes	Yes	Yes	Yes	Yes
3.06	1B1B	TYPE C	Yes		Yes	Yes	Yes	Yes	Yes	Yes	Yes	Yes	Yes

UNITING VIC TAS

PROJECT: 119 ALBERT STREET BALLARAT CENTRAL

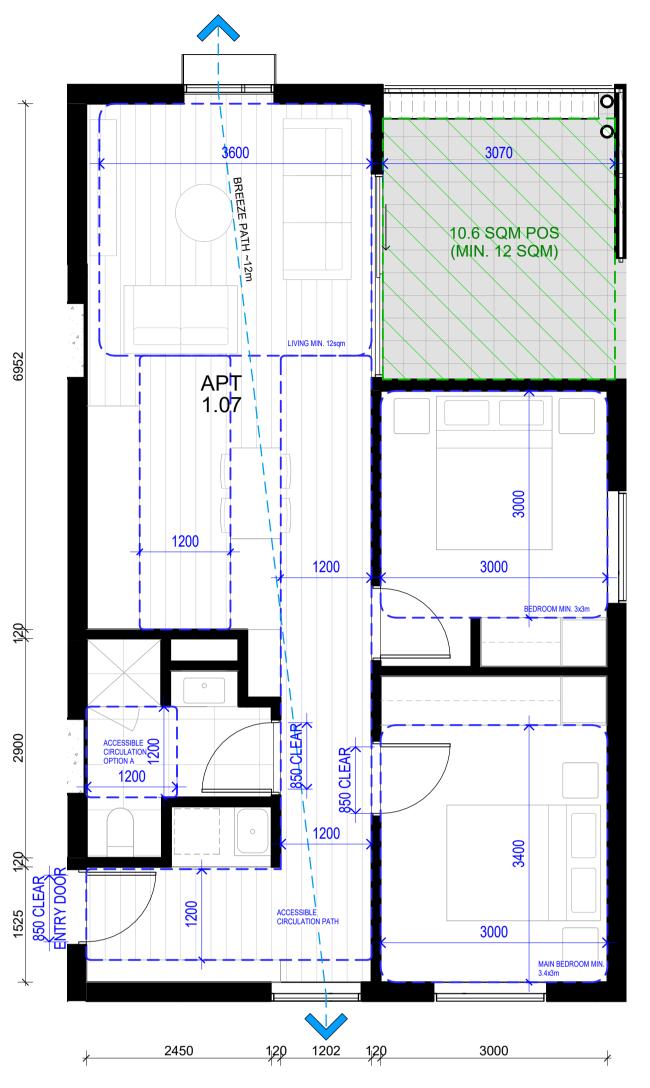

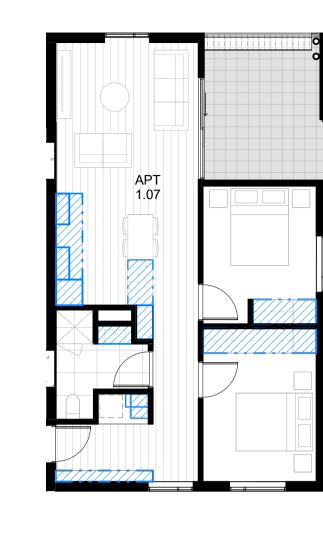


150

 \rightarrow

APT NO.	STORAGE TYPE	VOLUME
ALTINO.	STORAGETTIE	VOLONIE
1.07	FRIDGE O'HEAD	0.29 m ³
1.07	KITCHEN O'HEAD	0.24 m ³
1.07	KITCHEN O'HEAD	0.25 m ³
1.07	KITCHEN U'BENCH	0.64 m ³
1.07	KITCHEN U'BENCH	1.27 m ³
1.07	LAUNDRY O'HEAD	0.19 m ³
1.07	LAUNDRY U'BENCH	0.24 m ³
1.07	ROBE	2.63 m ³
1.07	ROBE	4.68 m ³
1.07	STORAGE CBD	1.74 m³
1.07	STORAGE CBD	0.91 m ³
1.07	VANITY	0.30 m ³
TOTAL		13.39 m ³


BADS ANALYSIS - 1.07 (TYPICAL TYPE - 2B1B) SCALE 1:50

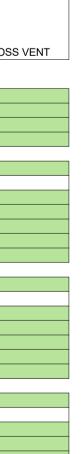

TYPICAL APARTMENTS (BADS COMPLIANCE) DATESCALEDRAWING NUMBERJUNE 2024As@ A1IndicatedTP0502

REPRODUCTION OF THE WH CONCEPTS CONTAINED IN TH INFORMATION, IDEAS AND CO MGS ARCHITECTS PTY LTD ABN 13 006 488 302 | MGSAR 10–22 MANTON LANE MELBOI

LEGEND DWELLING AMENITY (BADS COMPLIANCE)

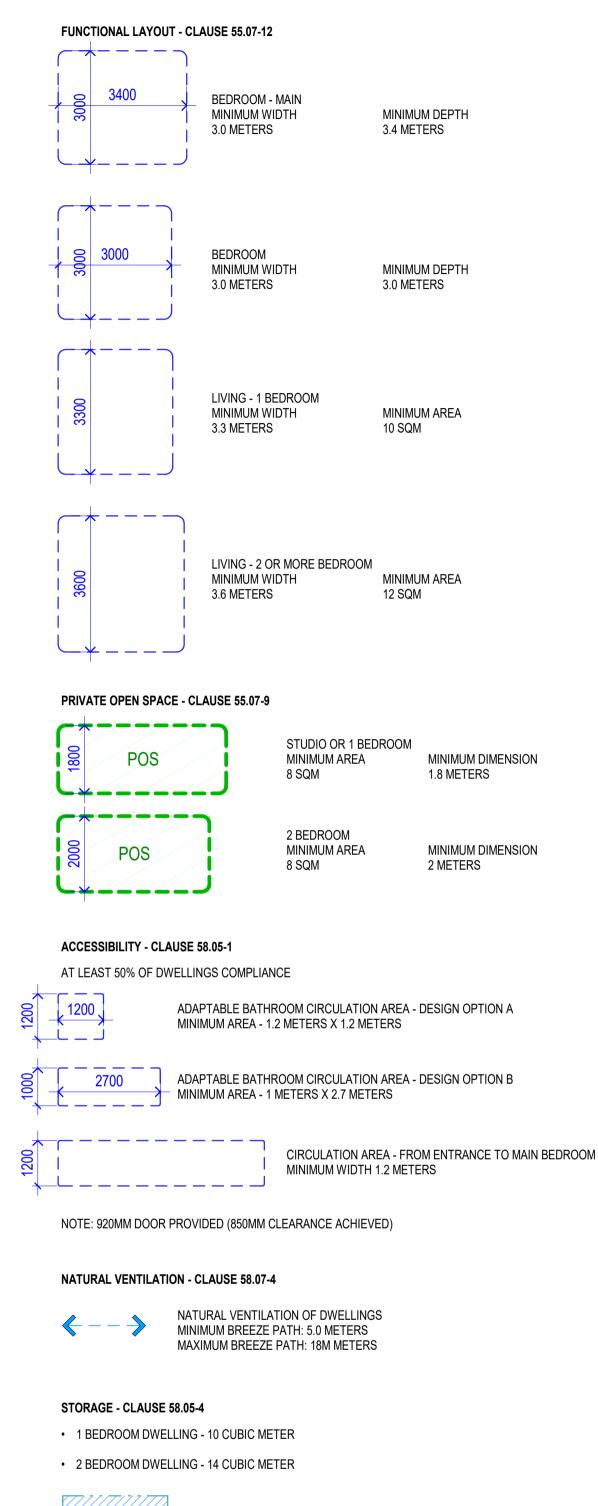


STORAGE VOLUME ANALYSIS

ROOM DEPTH - CLAUSE 58.07-2

THE FOLLOWING CEILING HEIGHT IS ADOPTED THROUGHT THE DEVELOPMENT:

- OPEN PLAN LIVING ROOM/KITCHEN 2.7M (LOCALIZED BULKHEAD ONLY TO ALLOW SERVICES 2.4M)
- BEDROOM 2.7M (LOCALIZED BULKHEAD ONLY TO ALLOW SERVICES 2.4M)
- BATHROOM 2.4M



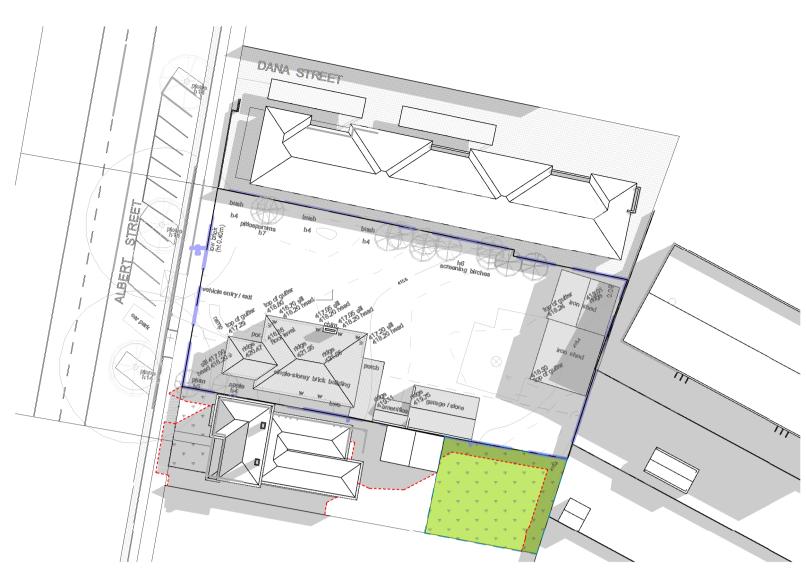

EXISTING SHADOW DIAGRAM 9AM - 22 SEPT SPRING EQUINOX SCALE 1:500



EXISTING SHADOW DIAGRAM 12PM - 22 SEPT SPRING EQUINOX SCALE 1:500

SCALE 1:500



LEGEND

LINE OF EXISTING CONDITION SHADOW


PROPOSED DEVELOPMENT SHADOW


EXISTING NEIGHBOUR SECLUDED PRIVATE OPEN SPACE (SPOS)

CLIENT UNITING VIC TAS

PROJECT : 119 ALBERT STREET BALLARAT CENTRAL


SCALE 1:500

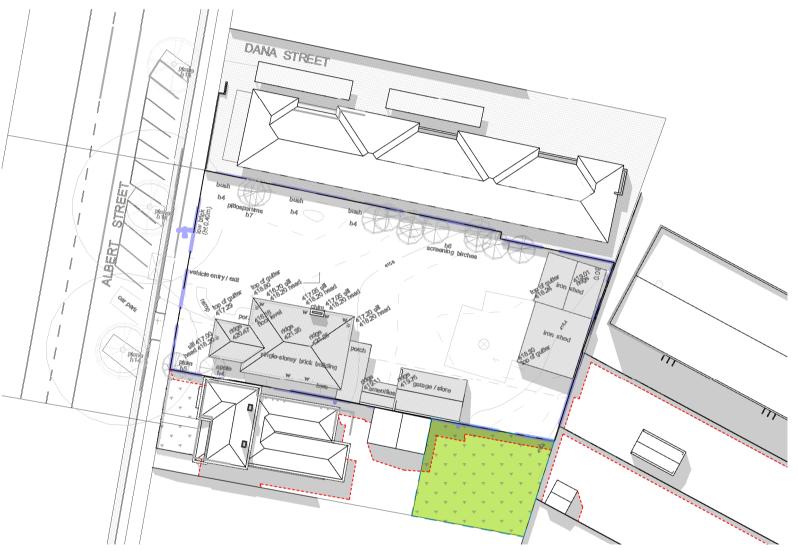

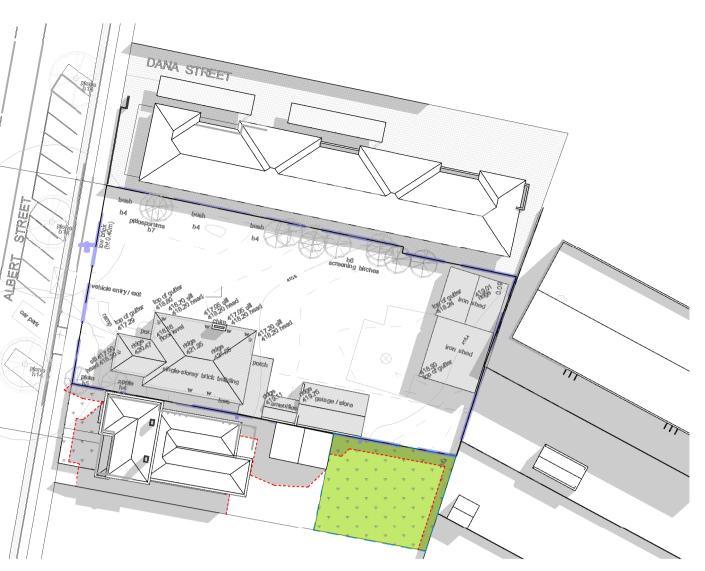


EXISTING SHADOW DIAGRAM 10AM - 22 SEPT SPRING EQUINOX


EXISTING SHADOW DIAGRAM 1PM - 22 SEPT SPRING EQUINOX

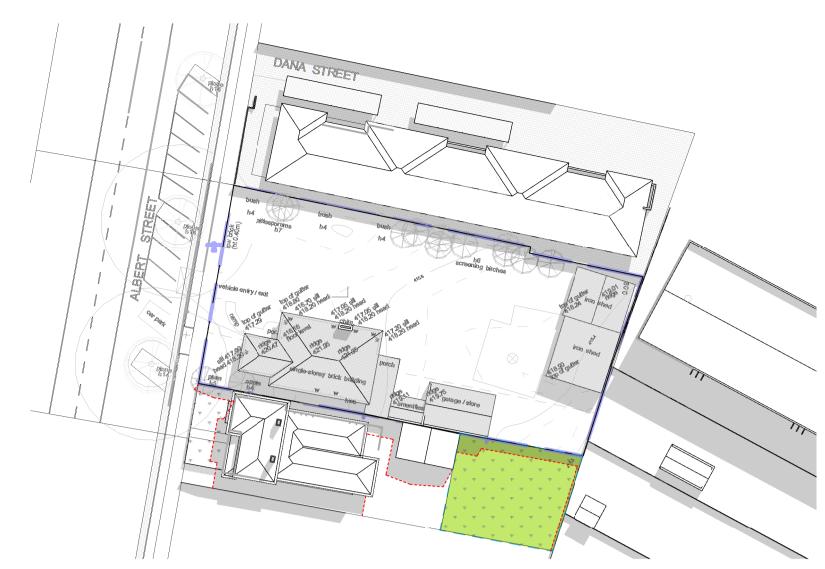

EXISTING SHADOW DIAGRAM 11AM - 22 SEPT SPRING EQUINOX SCALE 1:500

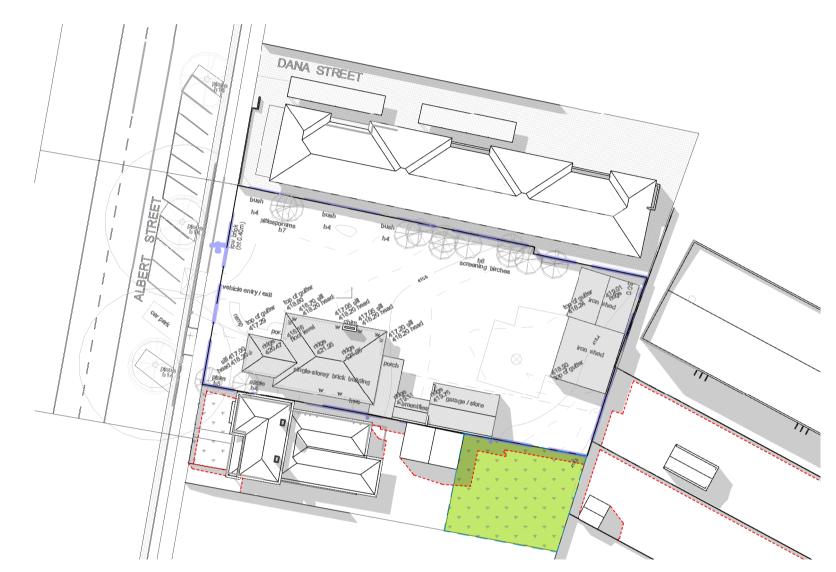

EXISTING SHADOW DIAGRAM 2PM - 22 SEPT SPRING EQUINOX SCALE 1:500

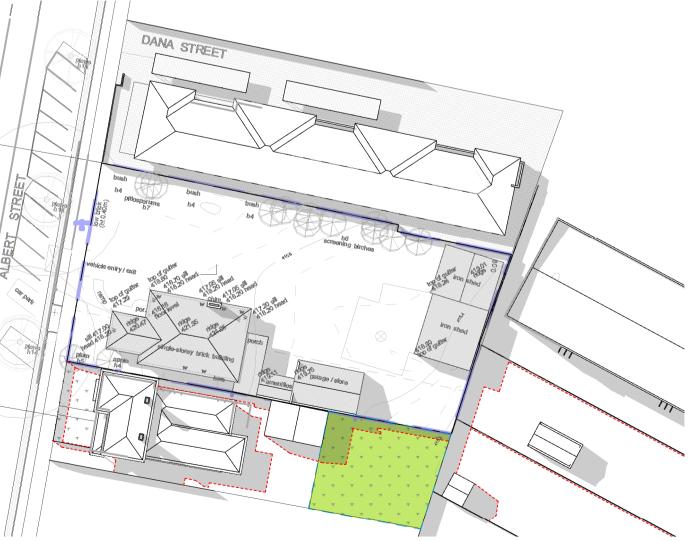

EXISTING SHADOW DIAGRAM 3PM - 22 SEPT SPRING EQUINOX SCALE 1:500




JUNE 2024 As DRAWING NUMBER @ A1 **TP0901** indicated





40sqm

PROPOSED SHADOW DIAGRAM 9AM - 22 SEPT SPRING EQUINOX SCALE 1:500 NEIGHBOUR SECLUDED PRIVATE OPEN SPACE (SPOS) : 210 SQM SHADOW AREA: 7+56 = 63 SQM (36%) SUNLIGHT TO NEIGHBOUR SPOS: 70%

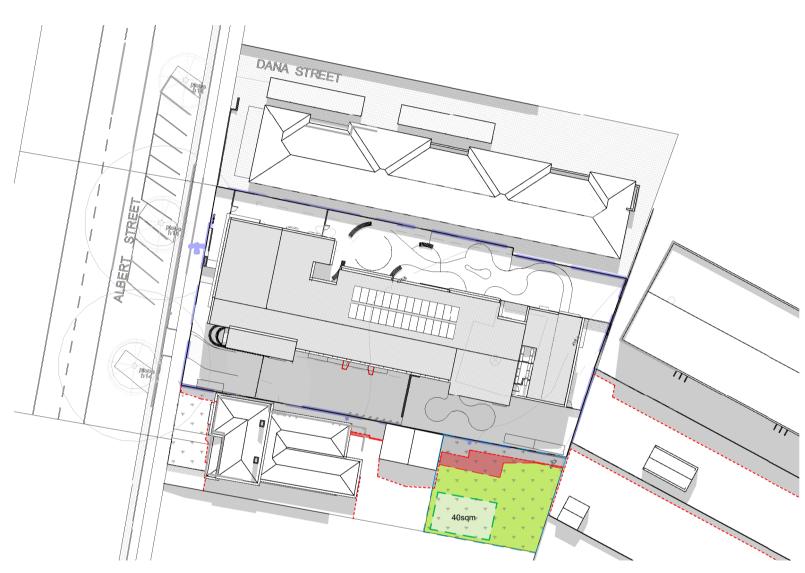

PROPOSED SHADOW DIAGRAM 12PM - 22 SEPT SPRING EQUINOX SCALE 1:500 NEIGHBOUR SECLUDED PRIVATE OPEN SPACE (SPOS) : 210 SQM SHADOW AREA: 21.7+28.6 = 50.3 SQM (24%) SUNLIGHT TO NEIGHBOUR SPOS: 76%

SCALE 1:500



LEGEND

LINE OF EXISTING CONDITION SHADOW

PROPOSED DEVELOPMENT SHADOW


EXISTING NEIGHBOUR SECLUDED PRIVATE OPEN SPACE (SPOS)

CLIENT UNITING VIC TAS


PROJECT : **119 ALBERT STREET** BALLARAT CENTRAL SCALE 1:500

40sqm

PROPOSED SHADOW DIAGRAM 10AM - 22 SEPT SPRING EQUINOX SCALE 1:500 NEIGHBOUR SECLUDED PRIVATE OPEN SPACE (SPOS) : 210 SQM SHADOW AREA: 11.7+42 = 53.7 SQM (25.5%) SUNLIGHT TO NEIGHBOUR SPOS: 74.5%

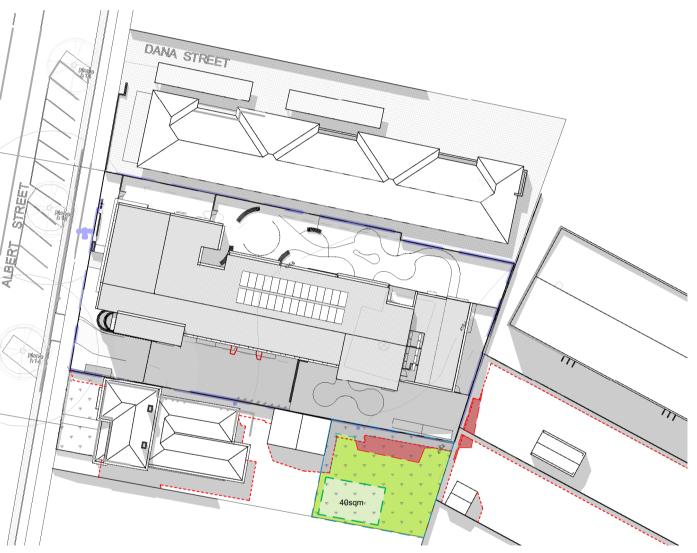

PROPOSED SHADOW DIAGRAM 1PM - 22 SEPT SPRING EQUINOX NEIGHBOUR SECLUDED PRIVATE OPEN SPACE (SPOS) : 210 SQM SHADOW AREA: 18.5+30.3 = 48.8 SQM (23.2%) SUNLIGHT TO NEIGHBOUR SPOS: 76.8%

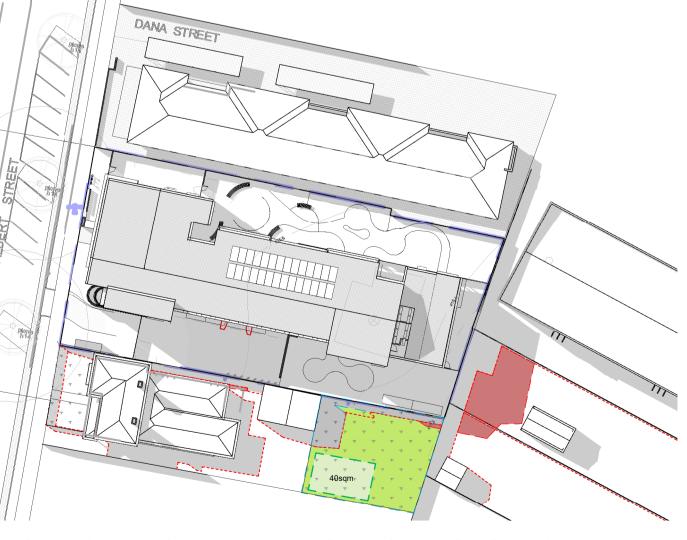


PROPOSED SHADOW DIAGRAM 3PM - 22 SEPT SPRING EQUINOX NEIGHBOUR SECLUDED PRIVATE OPEN SPACE (SPOS) : 210 SQM SHADOW AREA: 1.2+37.5 = 38.7 SQM (18.4%)

SUNLIGHT TO NEIGHBOUR SPOS: 81.6%

DRAWING TITLE

PROPOSED SHADOW DIAGRAMS

PROPOSED SHADOW DIAGRAM 11AM - 22 SEPT SPRING EQUINOX SCALE 1:500 NEIGHBOUR SECLUDED PRIVATE OPEN SPACE (SPOS) : 210 SQM SHADOW AREA: 20.3+31.6 = 51.9 SQM (24.7%) SUNLIGHT TO NEIGHBOUR SPOS: 75.3%

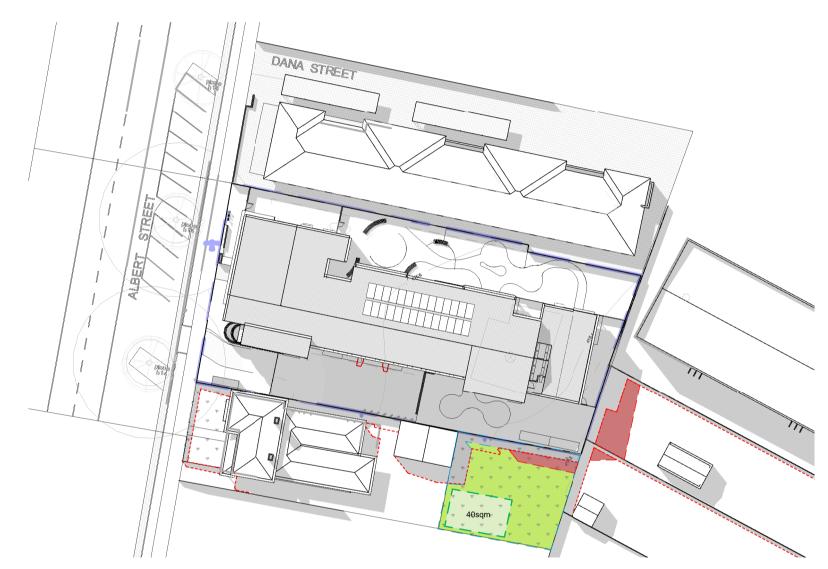

PROPOSED SHADOW DIAGRAM 2PM - 22 SEPT SPRING EQUINOX SCALE 1:500 NEIGHBOUR SECLUDED PRIVATE OPEN SPACE (SPOS) : 210 SQM SHADOW AREA: 11.4+32.4 = 43.8 SQM (20.8%) SUNLIGHT TO NEIGHBOUR SPOS: 79.2%

DRAWING NUMBER JUNE 2024 As @ A1 **TP0902** indicated

SCALE



